

25-ZA-06 Aerial Map 11800 Ford Road and 2645 LBJ Freeway





not have been prepared for or be suitable for legal, engineering, or surveying purposes. It does not represent an on-the ground survey and represents only the approximate relative location of property boundaries. Texas HB1147, Effective 9/1/2011



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Summary of Mailed Notices Property Owner List 25-ZA-06 2546 LBJ Freeway

Map	First Name	Address	City	State	Zip	Written Response
1.	PMC2201 LLC	1558 HIDALGO LN	FRISCO	TX	75034	None.
2.	DALLAS CHRISTIAN COLLEGE	FORD RD	FARMERS BRANCH	TX	75234	None.
3.	METRO GLEN LP C/O BOXER PROPERTY	7324 SOUTHWEST FWY STE 1900	HOUSTON	TX	77074	None.
4.	BOXER F2 LP C/O BOXER PPTY	720 N POST OAK RD STE 500	HOUSTON	TX	77024	None.
5.	HUSON INTERNATIONAL GROUP INC ATTN: JIMMY HSUEH	12005 FORD RD STE 520	DALLAS	TX	75234	None.
6.	METRO GLEN LP C/O BOXER PROPERTY	7324 SOUTHWEST FWY STE 1900	HOUSTON	TX	77074	None.
7.	METRO GLEN LP C/O BOXER PROPERTY	7324 SOUTHWEST FWY STE 1900	HOUSTON	TX	77074	None.
8.	METRO GLEN LP C/O BOXER PROPERTY	7324 SOUTHWEST FWY STE 1900	HOUSTON	TX	77074	None.
9.	ALPARC V GDIFORD PROPERTY	1600 MARKET ST STE 2600	PHILADELPHIA	PA	19103	None.
10.	BOXER F2 LP C/O BOXER PPTY	720 N POST OAK RD STE 500	HOUSTON	TX	77024	None.
11.	DALLAS CHRISTIAN COLLEGE	2700 CHRISTIAN PKWY	DALLAS	TX	75234	None.
12.	DEEP 6 PROPERTIES INC	800 FABRIC XPRESS WAY	DALLAS	TX	75234	None.
13.	MANSA DALLAS HOTEL LLC	2645 LYNDON B JOHNSON FWY	FARMERS BRANCH	TX	75234	None.
14.	BALDWIN HARRIS CO	9400 N CENTRAL EXPY STE 320	DALLAS	TX	75231	None.
15.	CARROLLTON-FARMERS BRANCH ISD	1445 N. PERRY ROAD	CARROLLTON	TX	75006	None.
16.	DALLAS INDEPENDENT SCHOOL DISTRICT	9400 N. CENTRAL EXPRESSWAY	DALLAS	TX	75231	None.

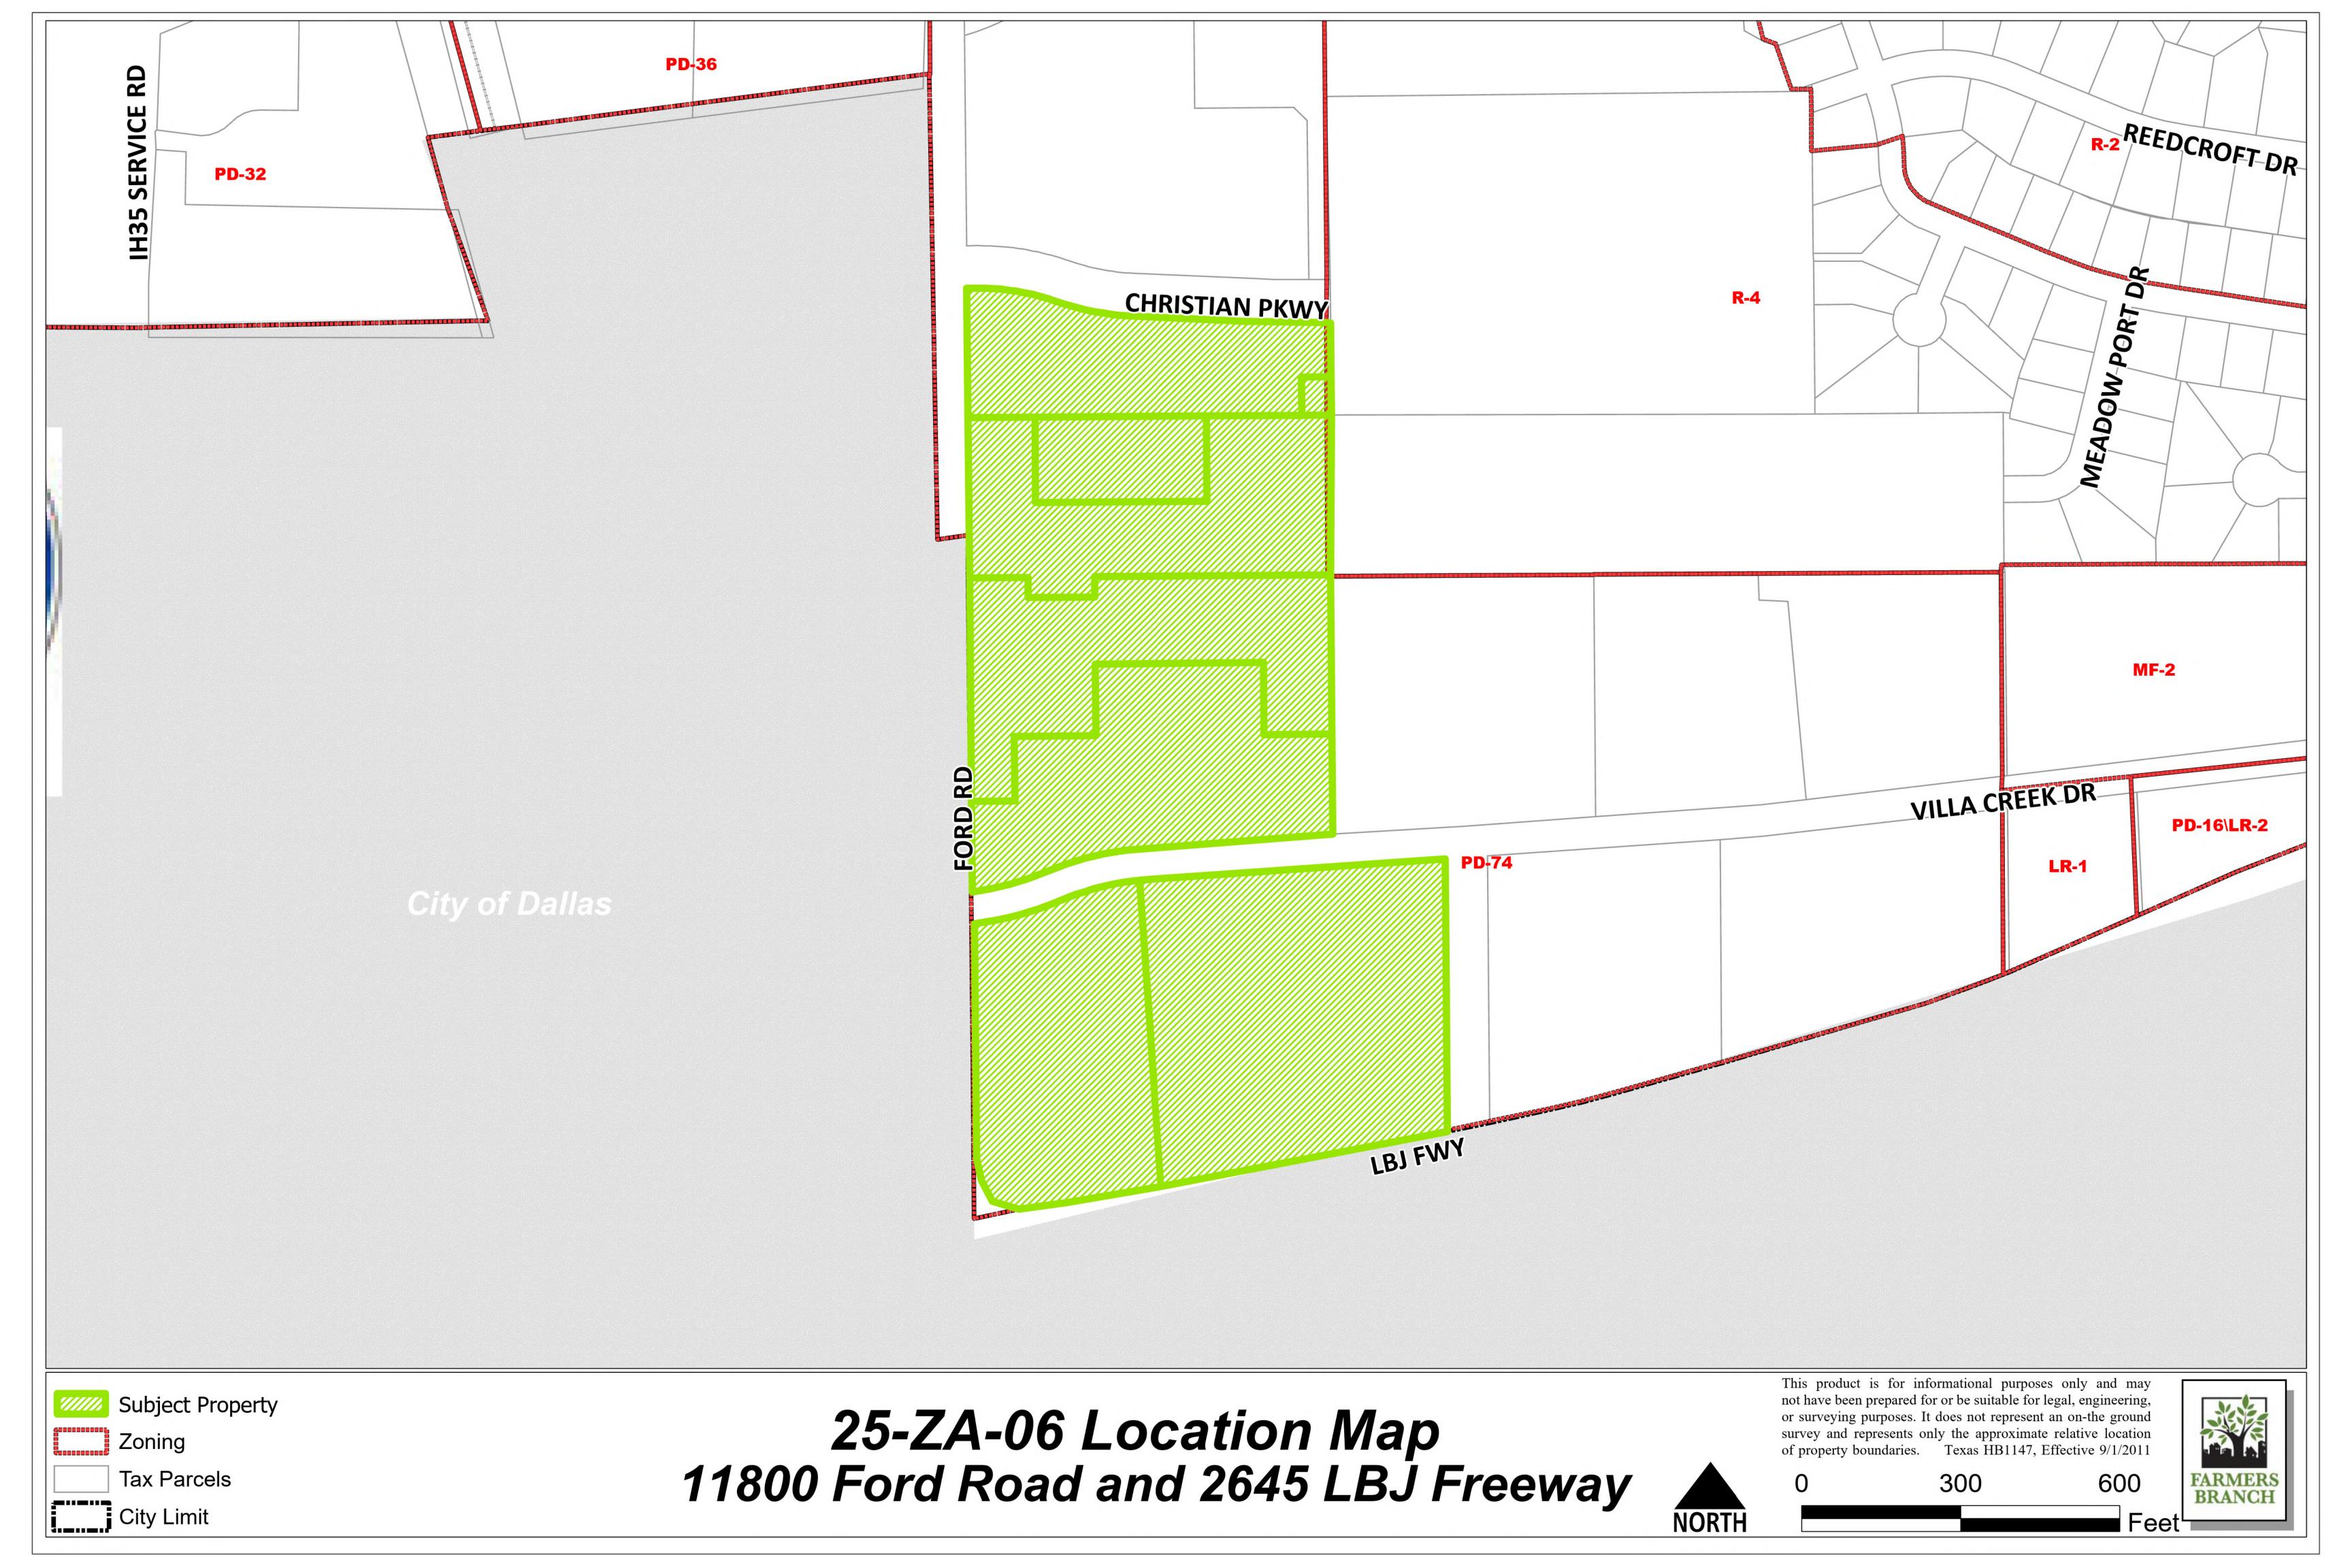

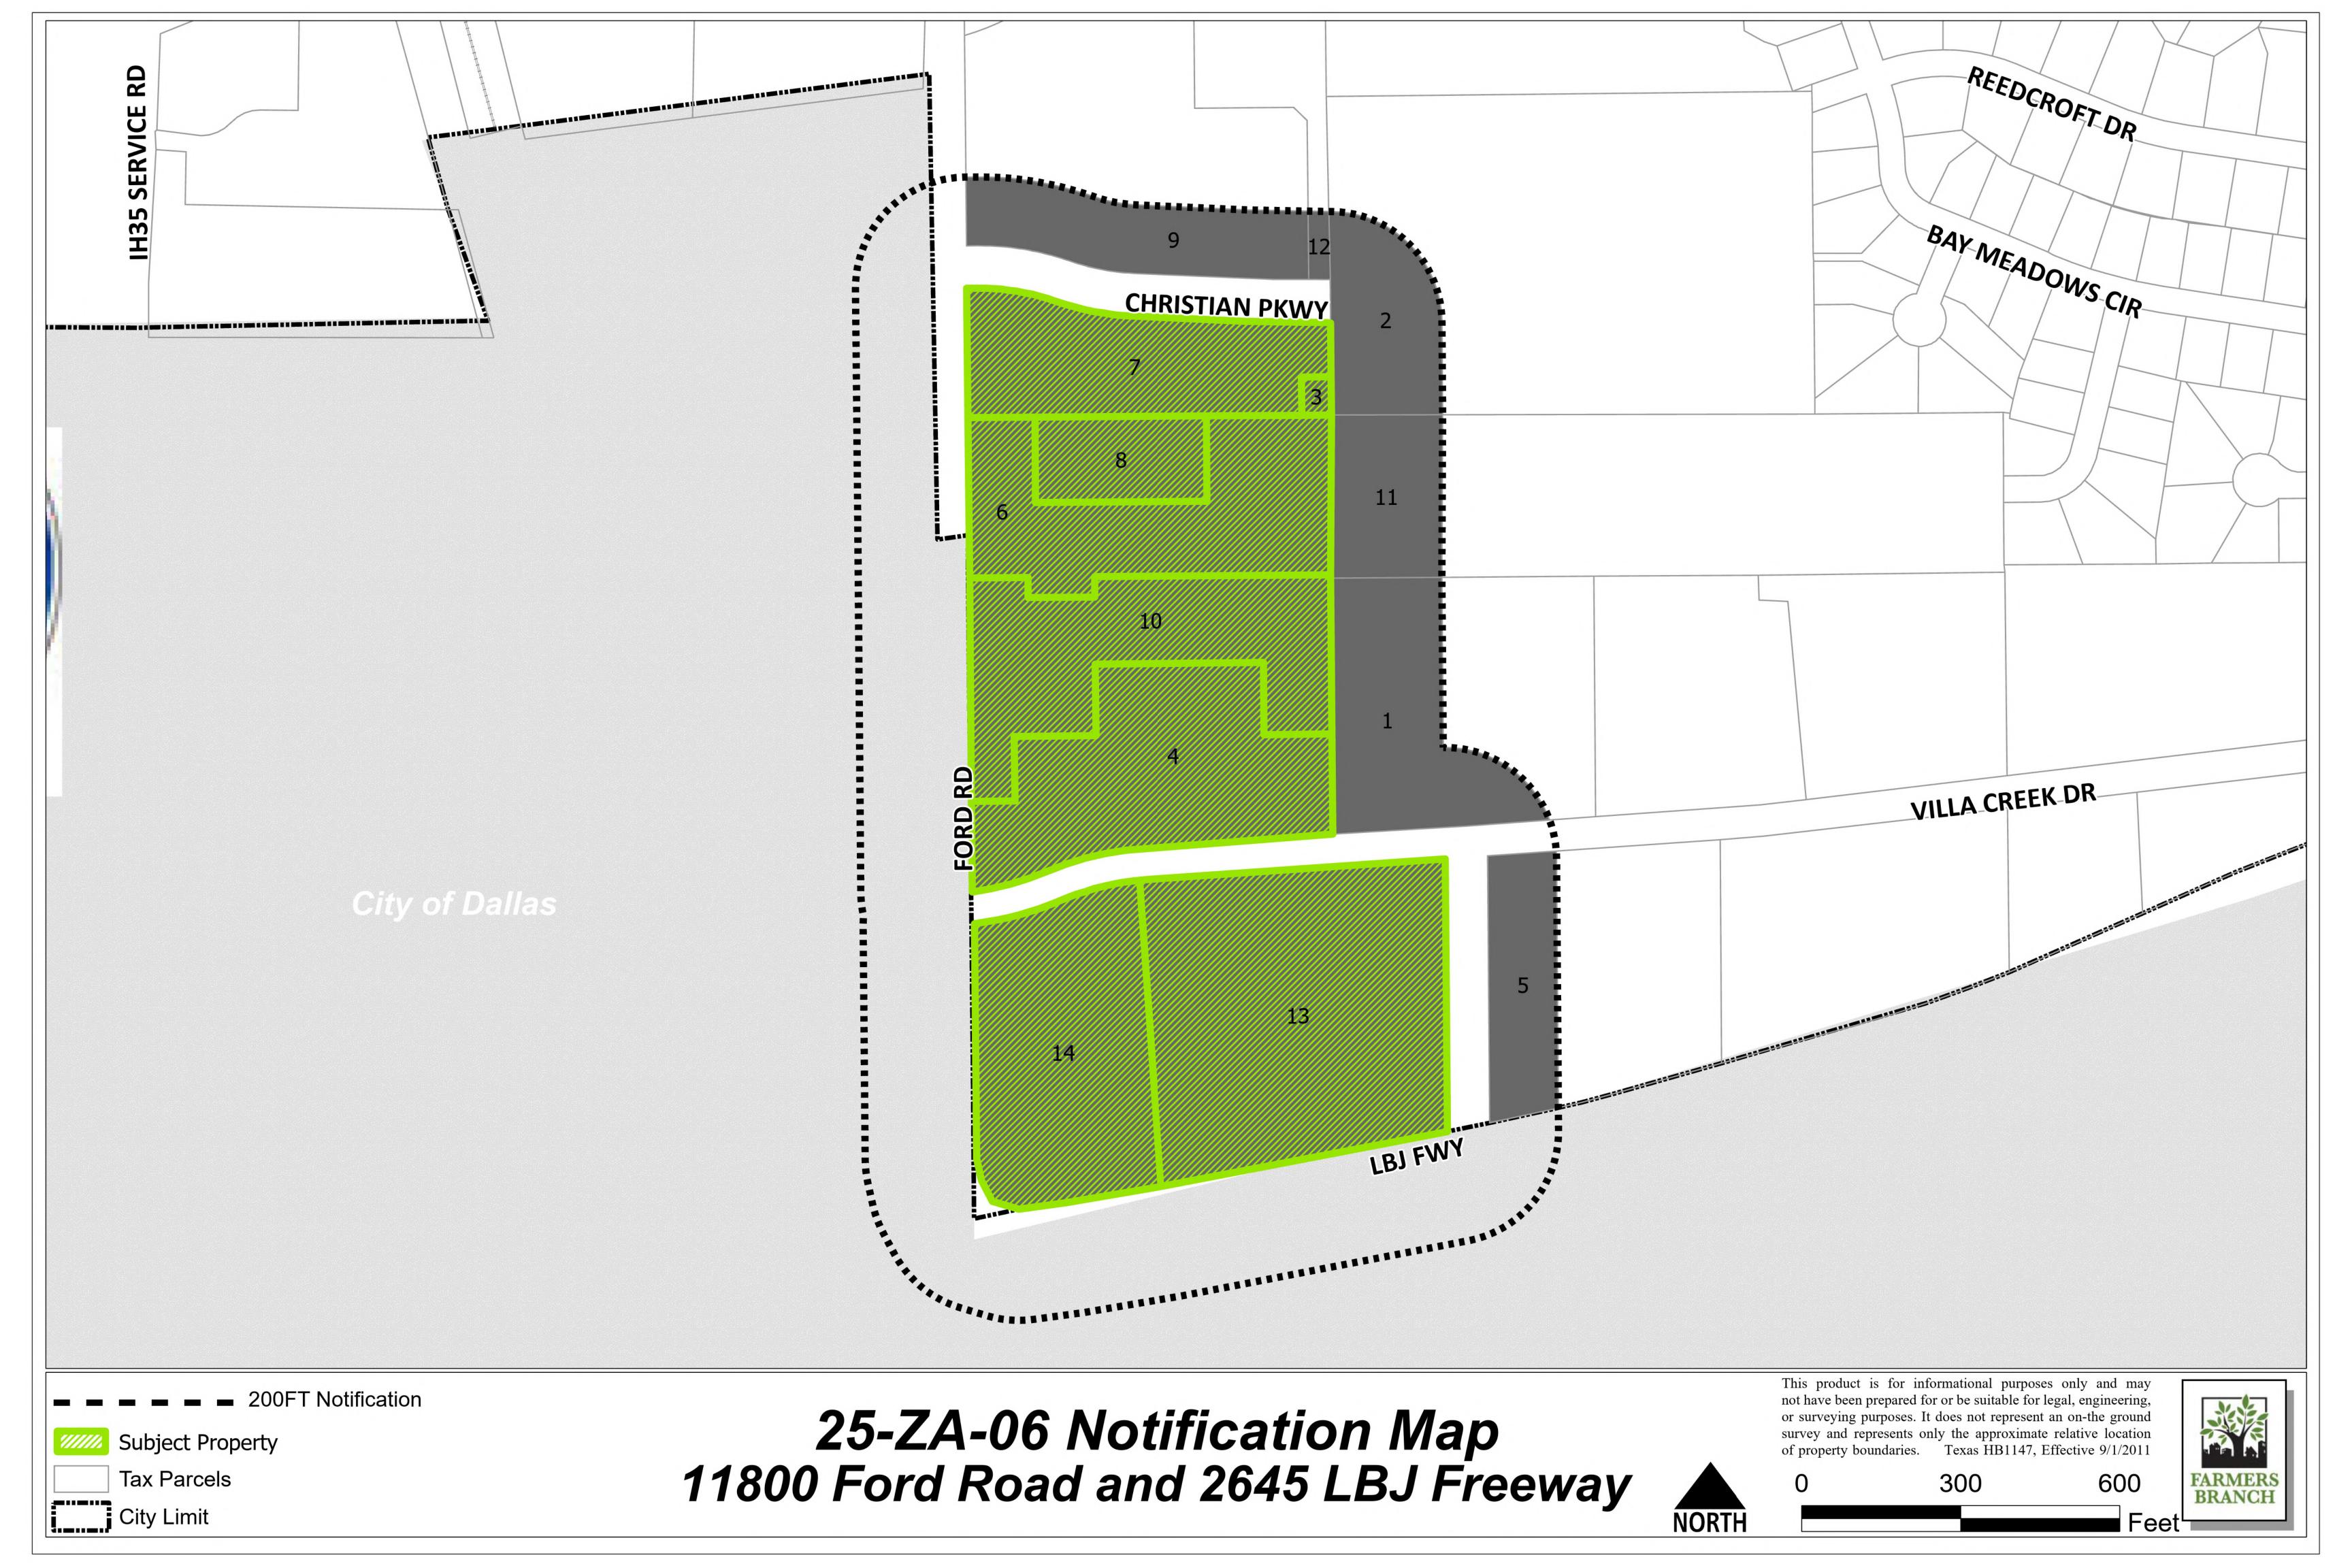City of Farmers Branch

City Hall 13000 Wm. Dodson Pkwy Farmers Branch, TX 75234

Action Meeting Minutes (EXCERPT)

Planning and Zoning Commission

Monday, June 9, 2025 7:00 PM City Hall

The full video of this meeting is available on the City website here: https://farmersbranch.legistar.com/Calendar.aspx

Commissioners Present (8): Chair Amber Raley, Vice-Chair Marcus Miller, Commissioner Alden Sultzbaugh,

Commissioner Colin Kirby, Commissioner Pat Trapp, Commissioner Harold Froehlich, Alternate Commissioner Scott Noris, and Alternate Commissioner

Breeanna Banks

Commissioners Absent (1): Commissioner Dan Heard

City Staff Present: Deputy Director of Planning Sarah Bergman AICP; Lead Planner Brett Mangum

AICP; Planner Brian Campbell; Deputy City Manager Jawaria Tareen; City

Attorney Nicole Corr; Assistant City Attorney Sarah Walsh

H. PUBLIC HEARING

H.1 25-ZA-06

Conduct a public hearing and consider the request for a zoning amendment for industrial development on approximately 28 acres located at 2645 LBJ Freeway within Planned Development District No. 74 (PD-74); and take appropriate action.

Mr. Mangum gave a presentation regarding the proposed amendment.

Mr. Mangum answered questions from Commissioners regarding: previous zoning approvals for this site, total square footage for each building, the definitions of warehouse/distribution, light assembly, and light fabrication, traffic impact with the addition of a fourth warehouse building, and the comprehensive plan recommendation for this site.

Hearing no further questions or comments from the Commissioners, Chair Raley opened the public hearing.

Kyle McCullah, 18383 Preston Road, Dallas, TX, and Robert Dye, 13218 Bee Street, Farmers Branch, TX, representatives for the applicant, answered questions from the Commissioners regarding potential future tenants for this development, the type of screening wall proposed between this site and Dallas Christian College, travel routes for large trucks entering and exiting this development, and demolition process for the Wyndham Garden hotel.

A motion was made by Vice-Chair Miller, seconded by Commissioner Kirby, that the public hearing be closed. The motion carried unanimously.


Aye: 7 – Chair Raley, Vice-Chair Miller, Commissioner Sultzbaugh, Commissioner Commissioner Kirby, Commissioner Froehlich, Commissioner Trapp, Alternate


Commissioner Noris

A motion was made by Commissioner Kirby, seconded by Commissioner Trapp, that this Zoning Amendment be recommended for approval. The motion carried unanimously.

Aye: 7 – Chair Raley, Vice-Chair Miller, Commissioner Sultzbaugh, Commissioner Commissioner Kirby, Commissioner Froehlich, Commissioner Trapp, Alternate Commissioner Noris


Chair Raley asked when this case would be considered by City Council. Ms. Bergman stated at their June 17, 2025 meeting.

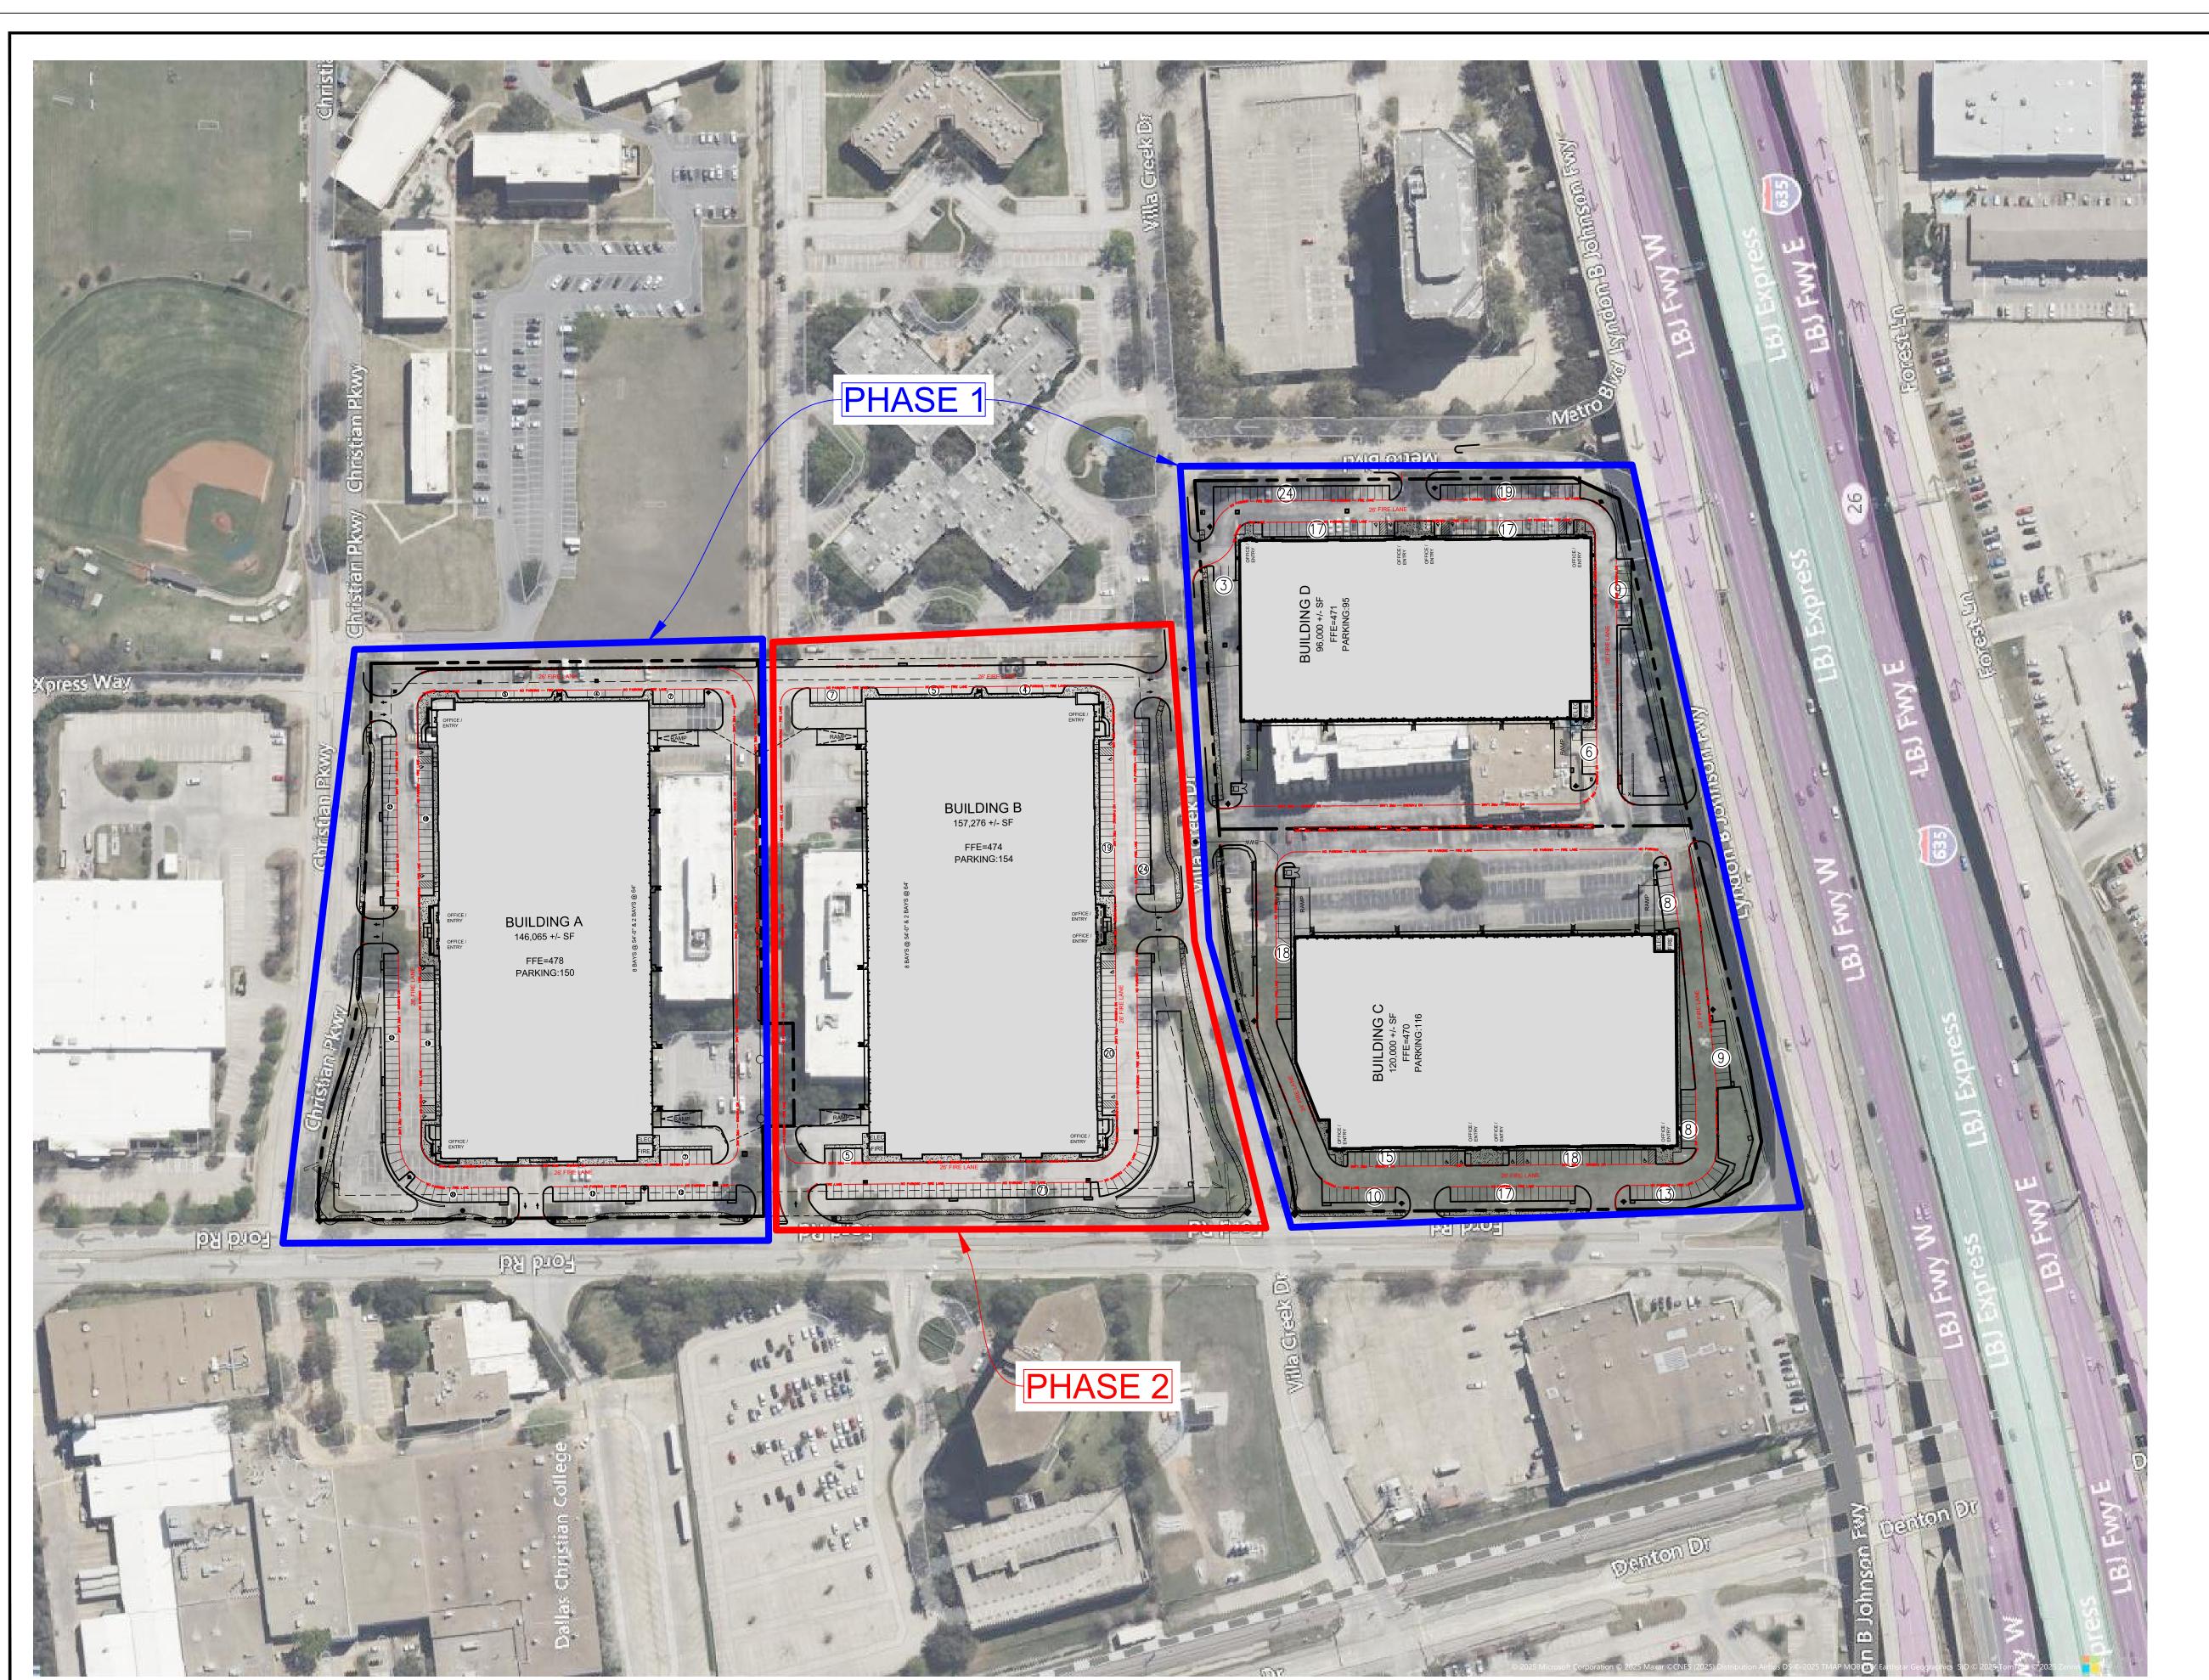


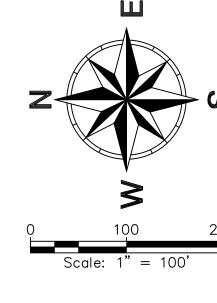

6-6-2025

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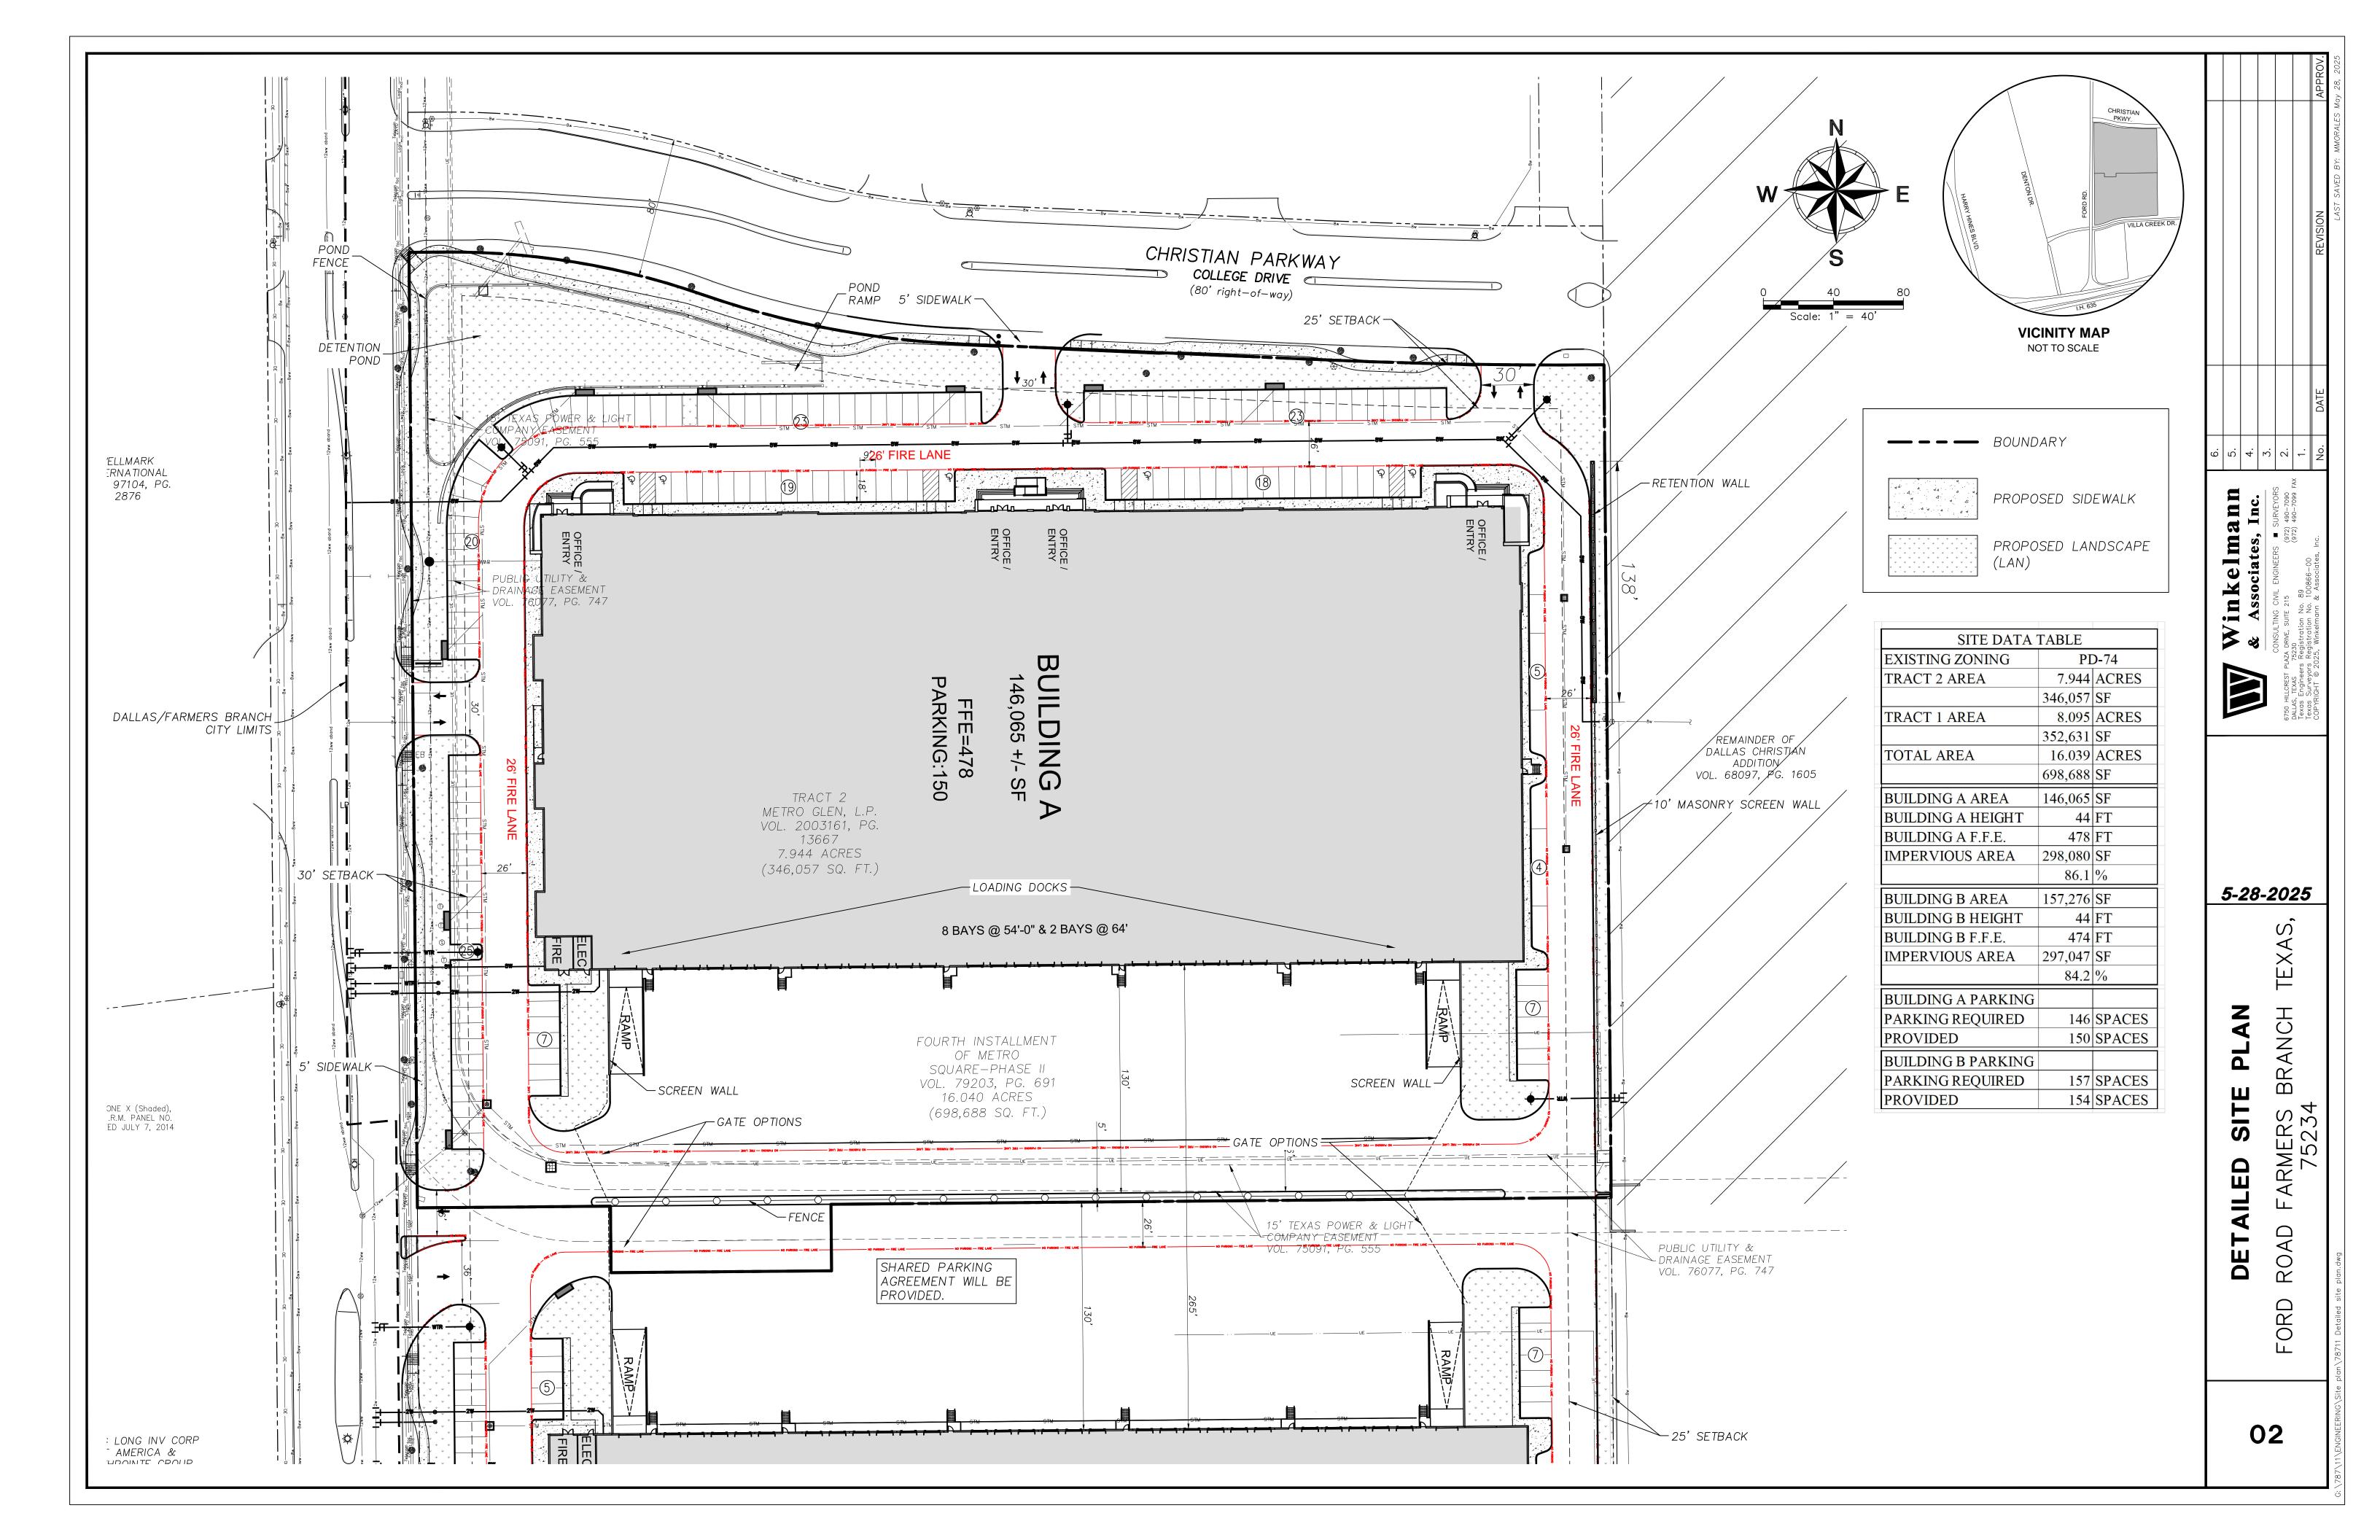
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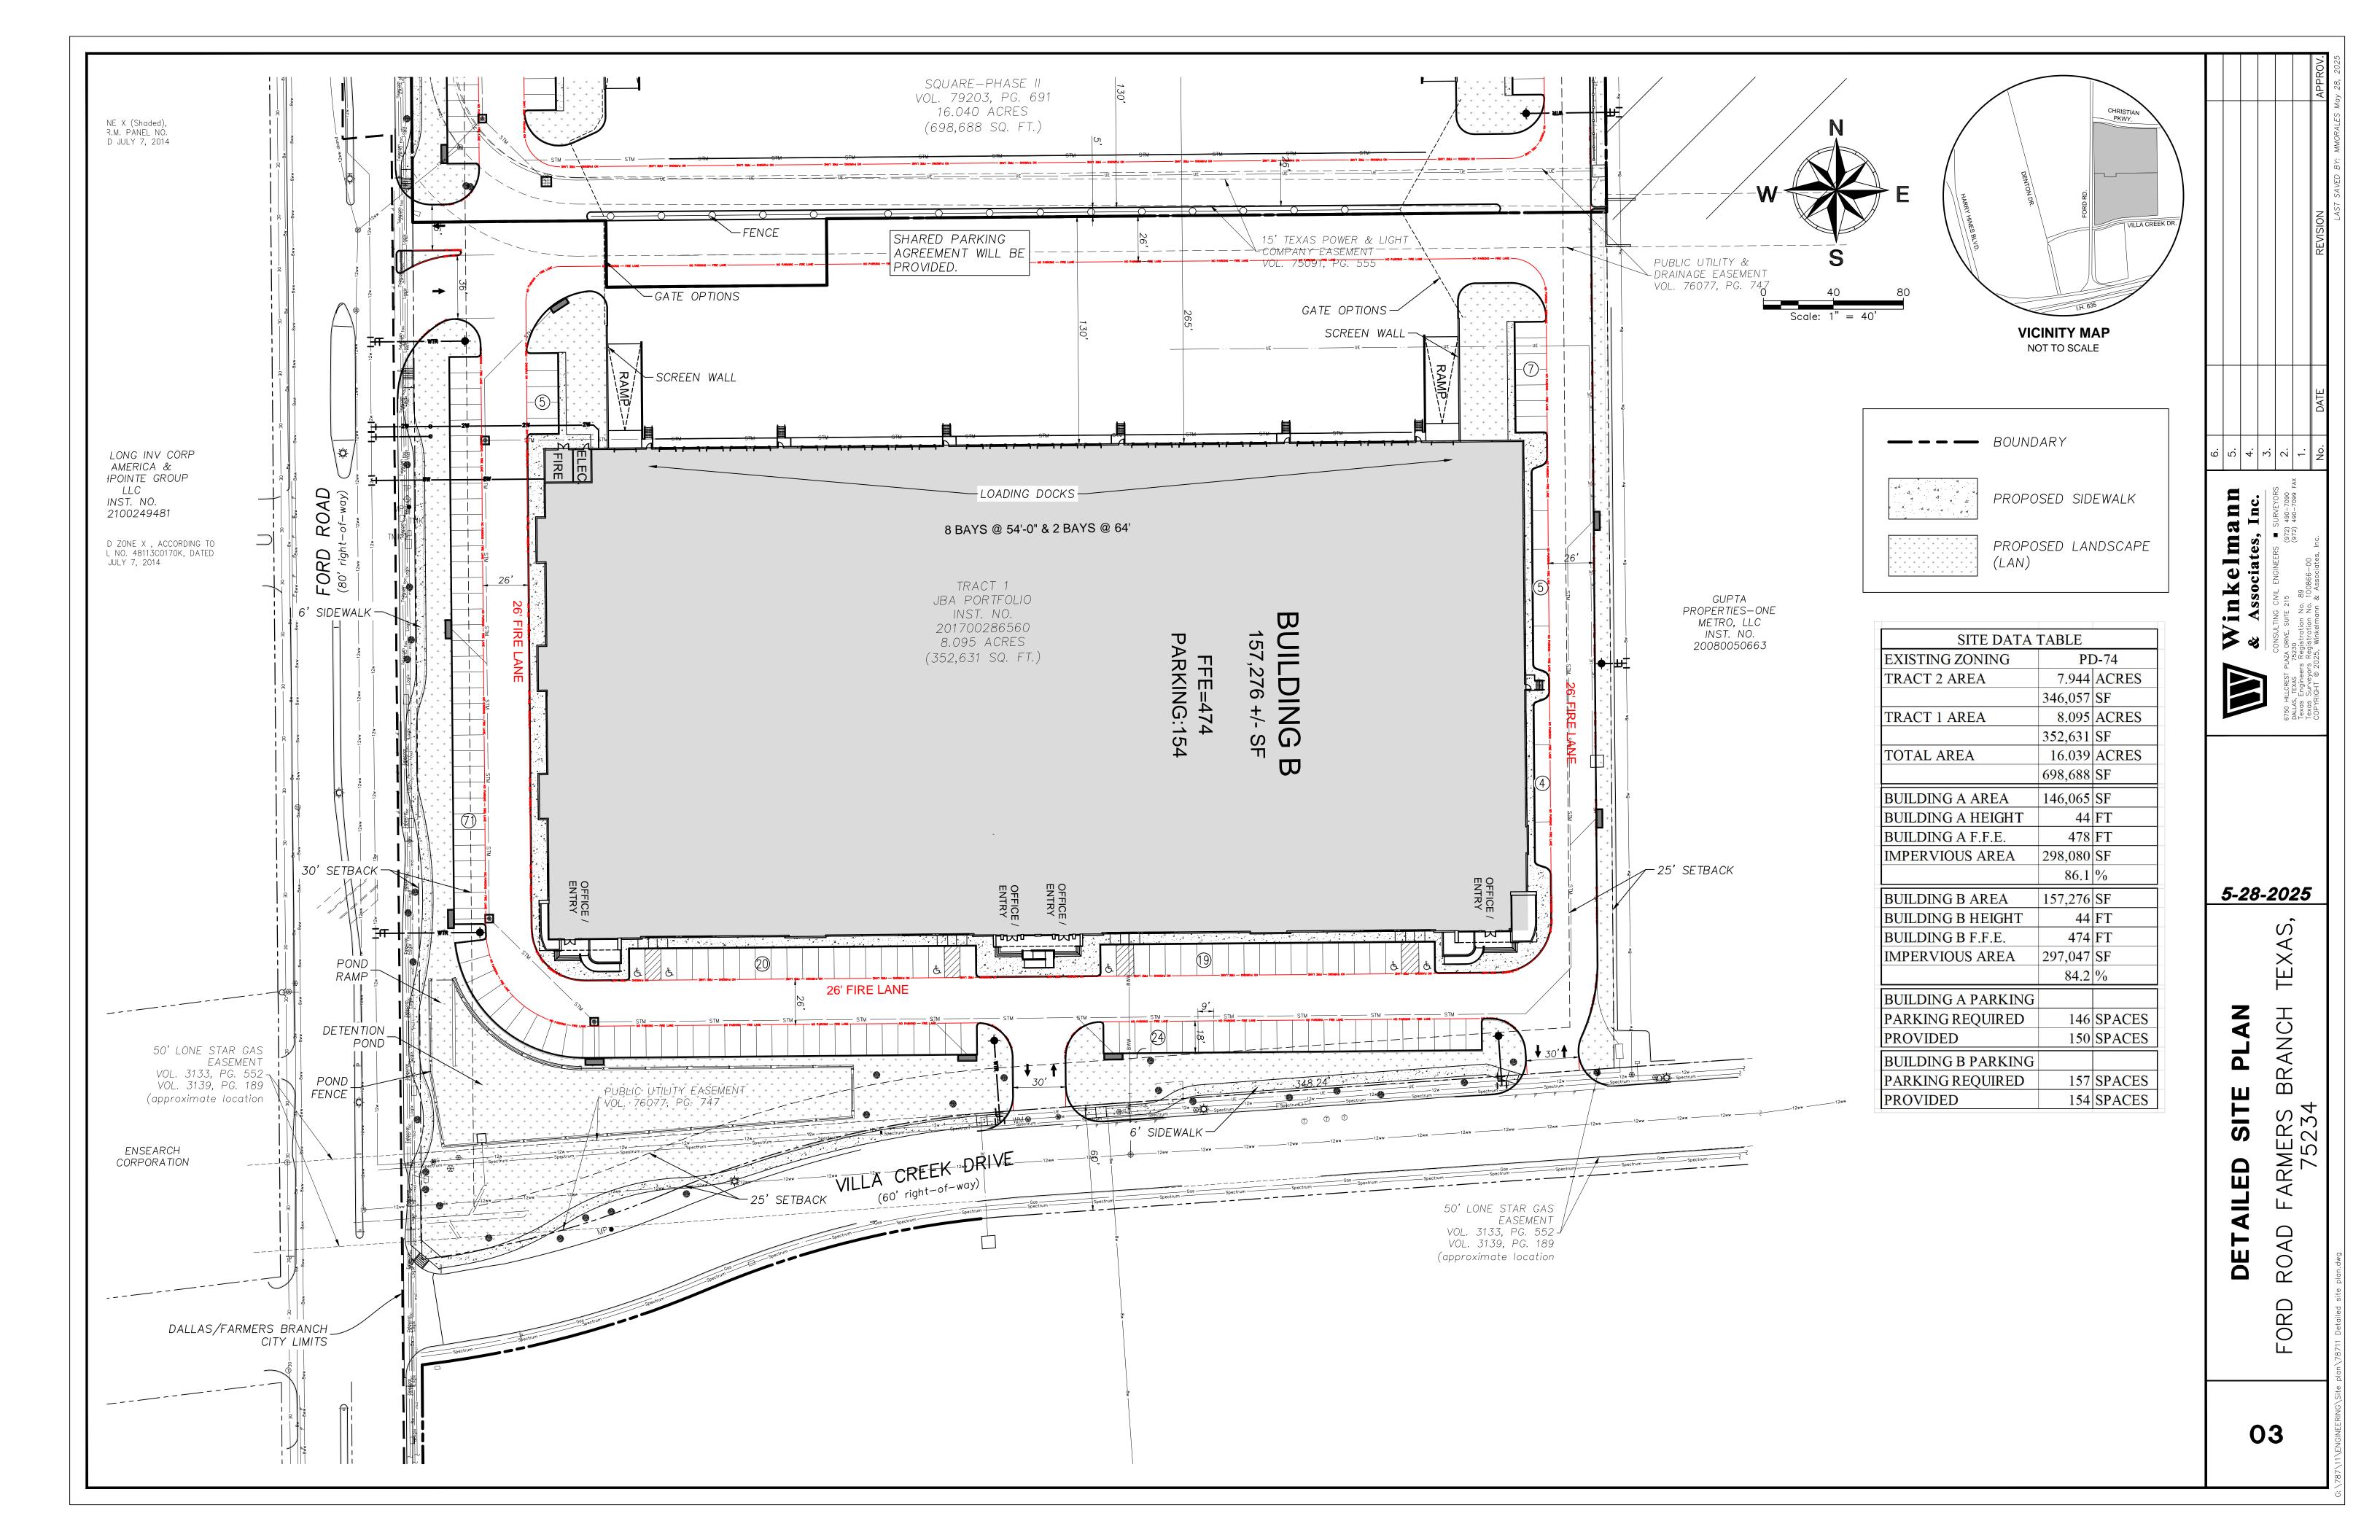
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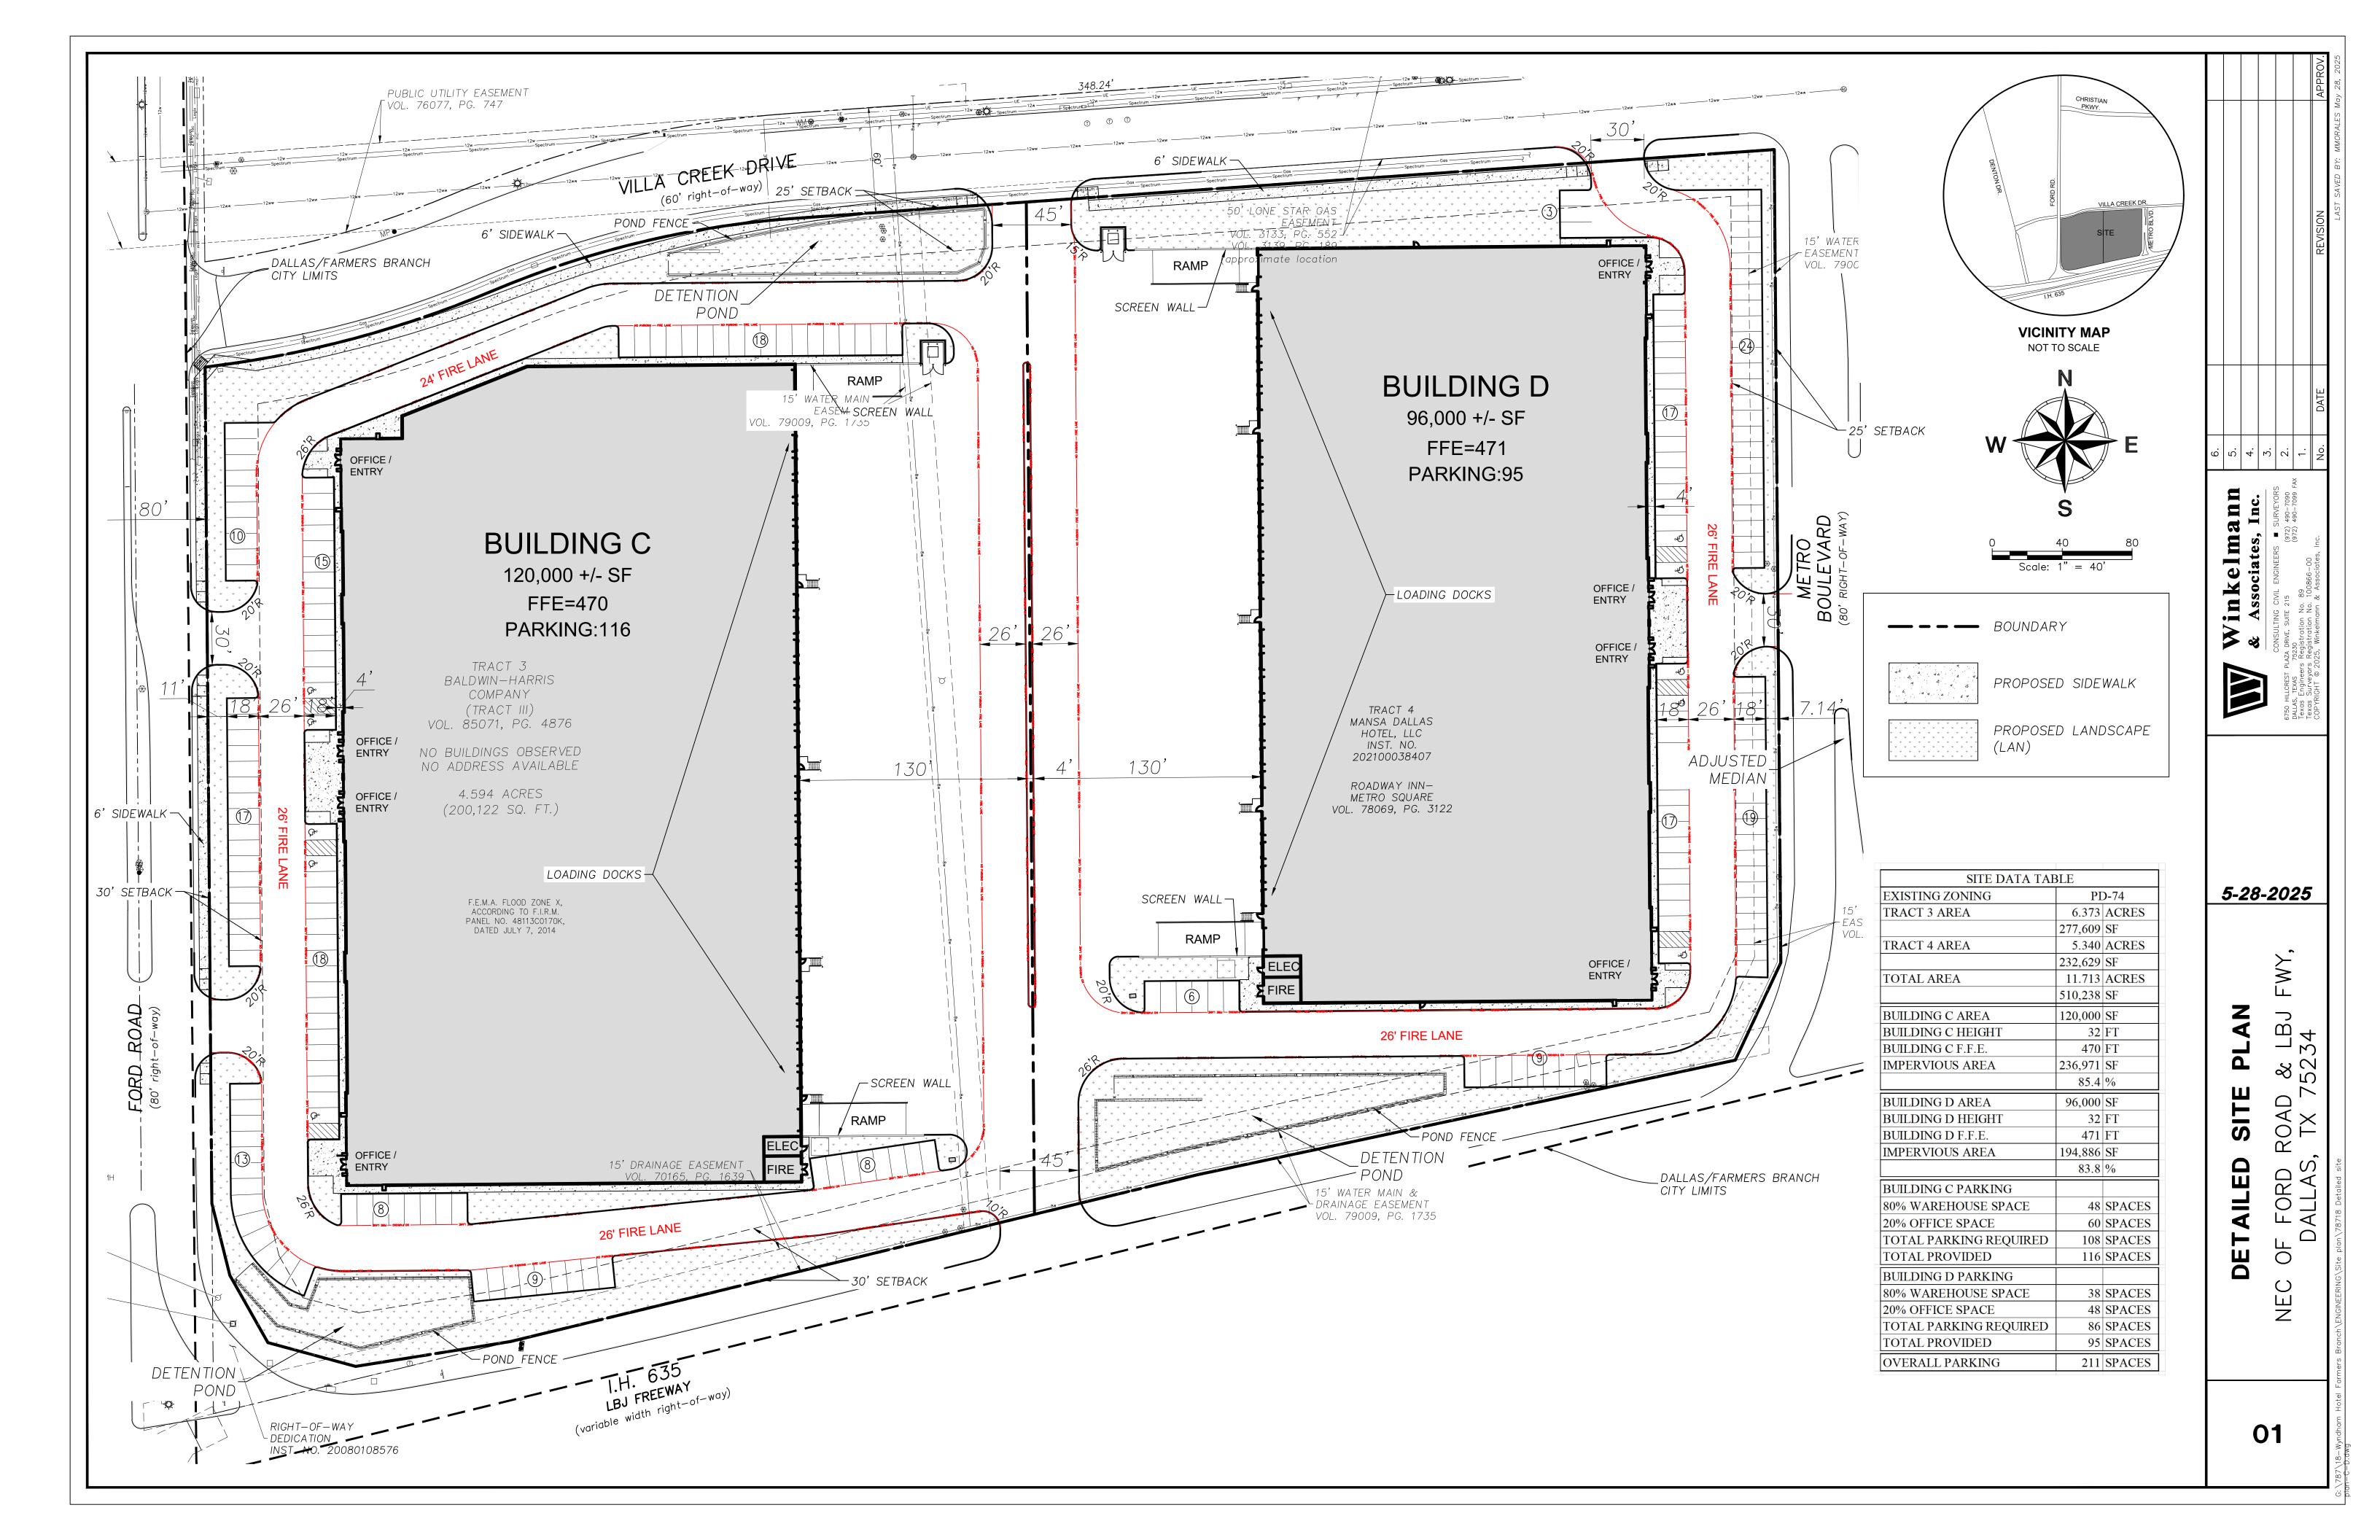
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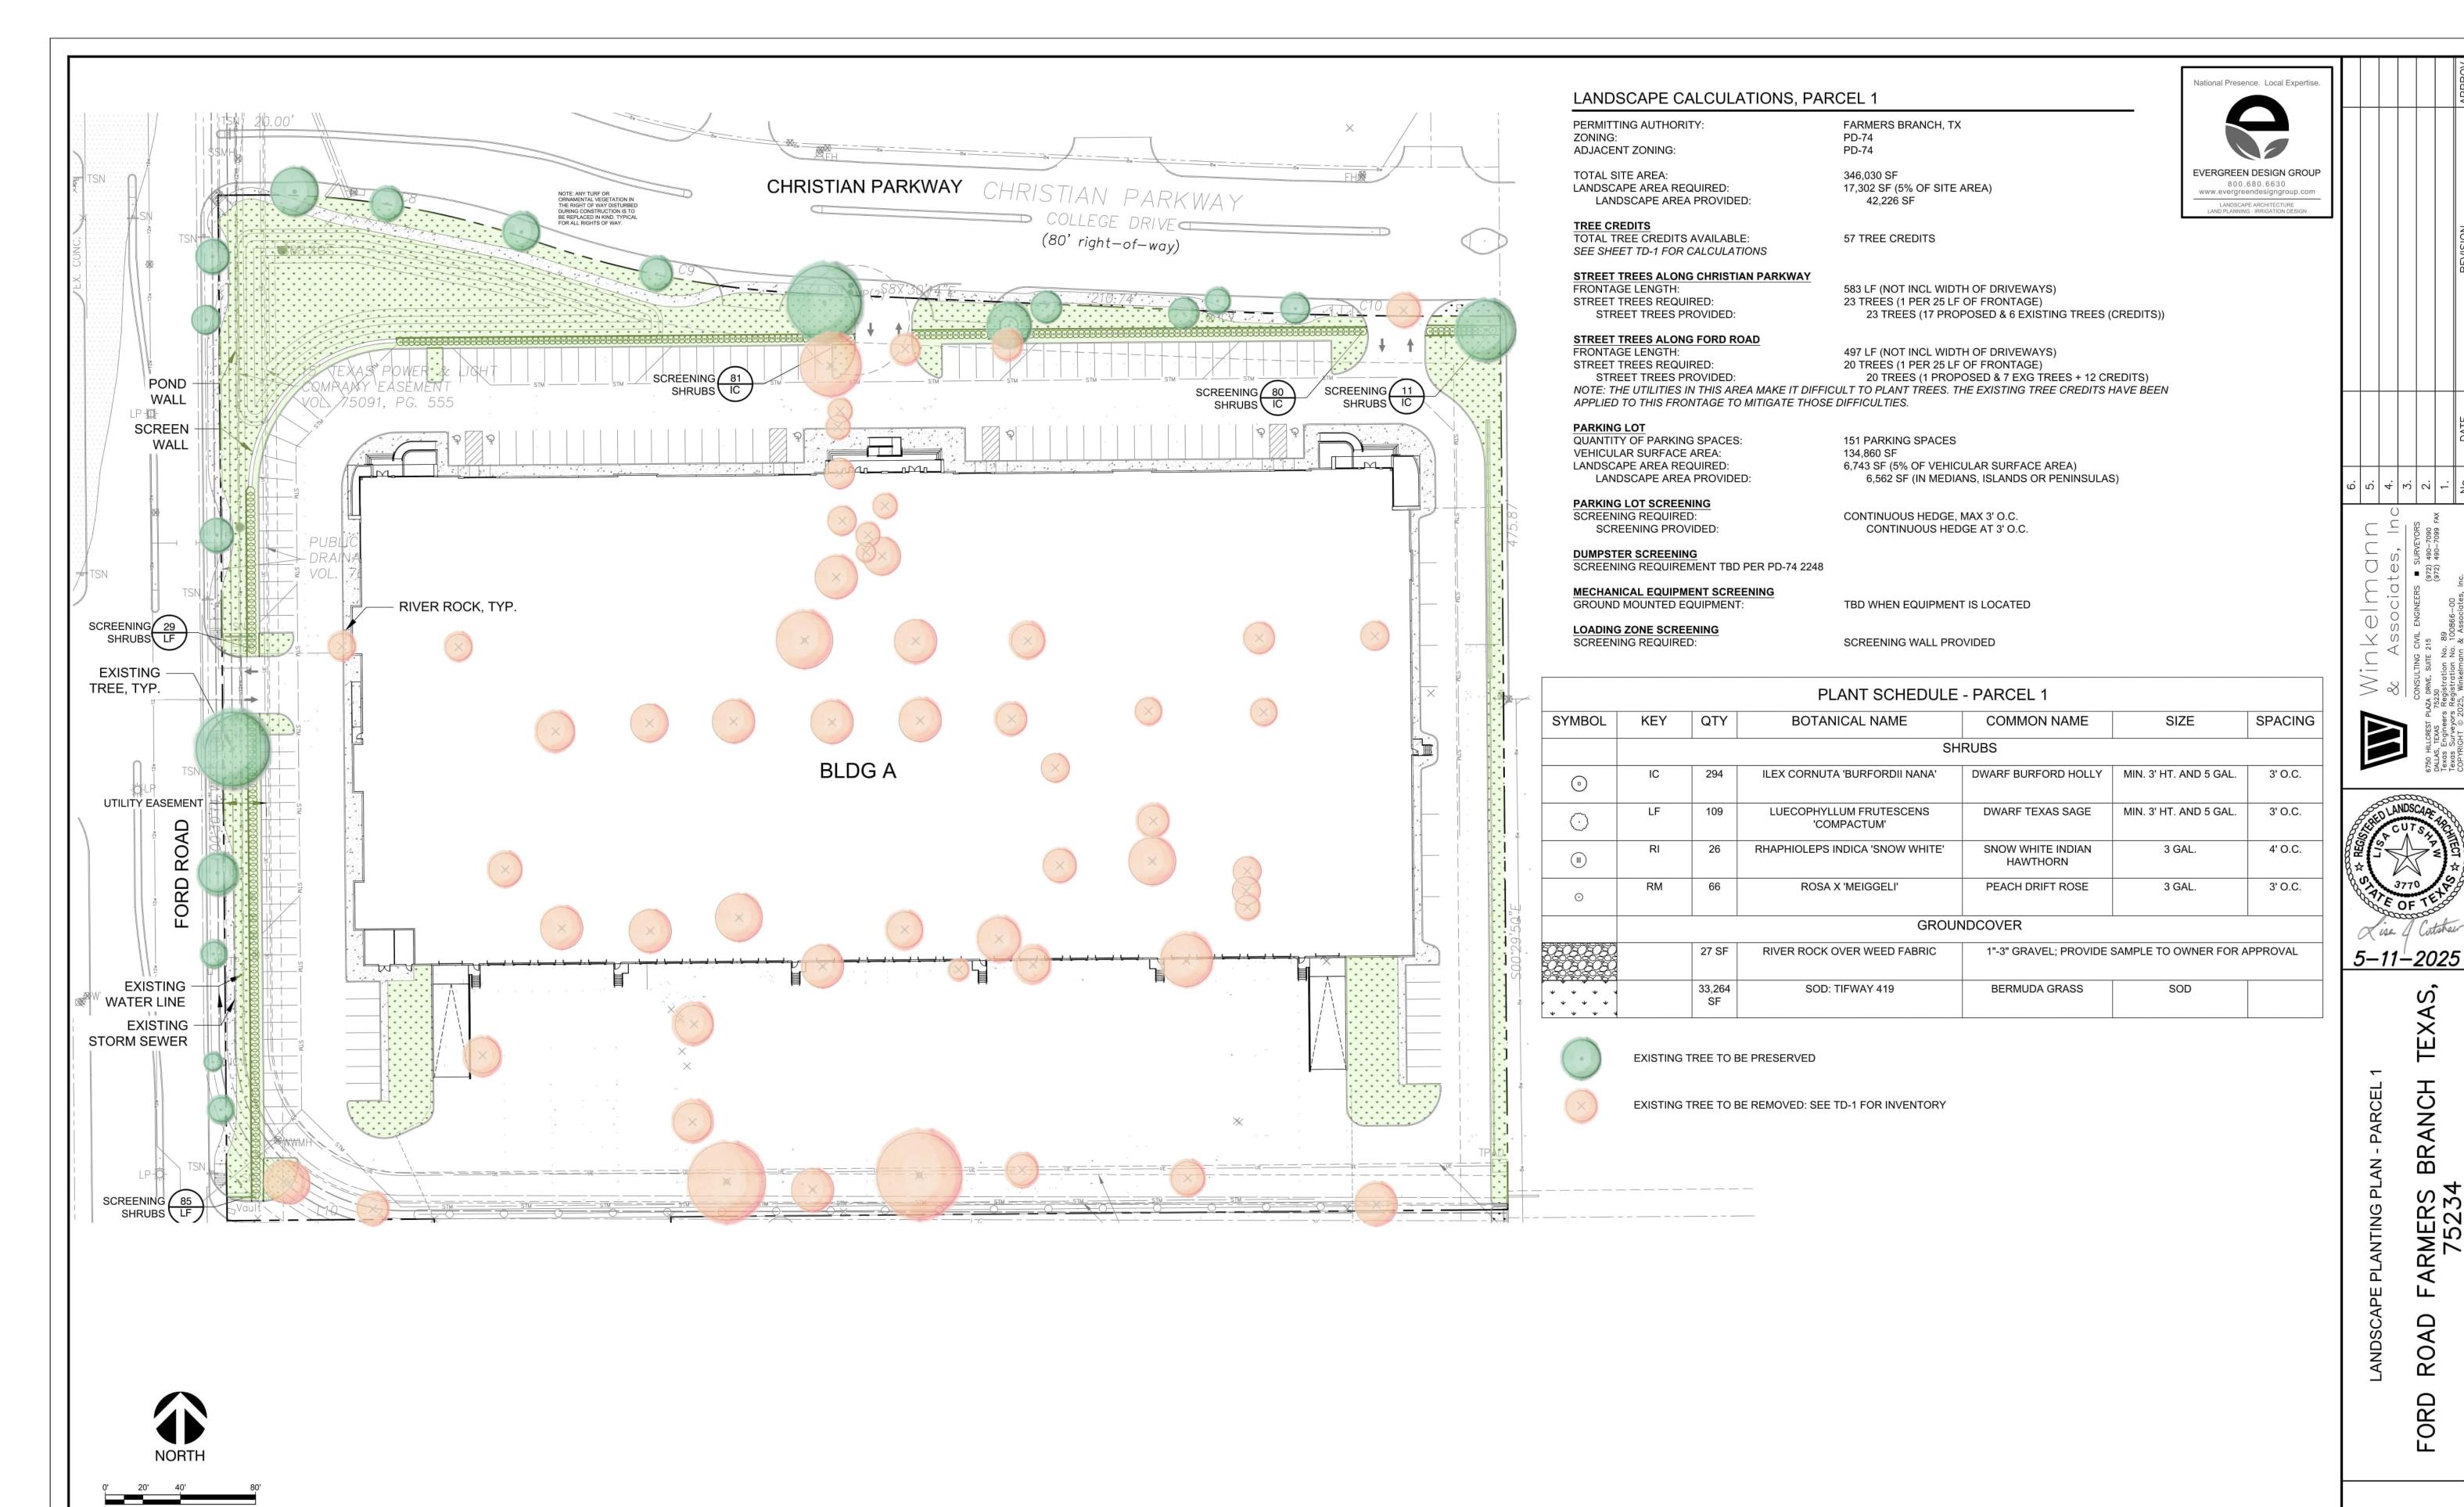
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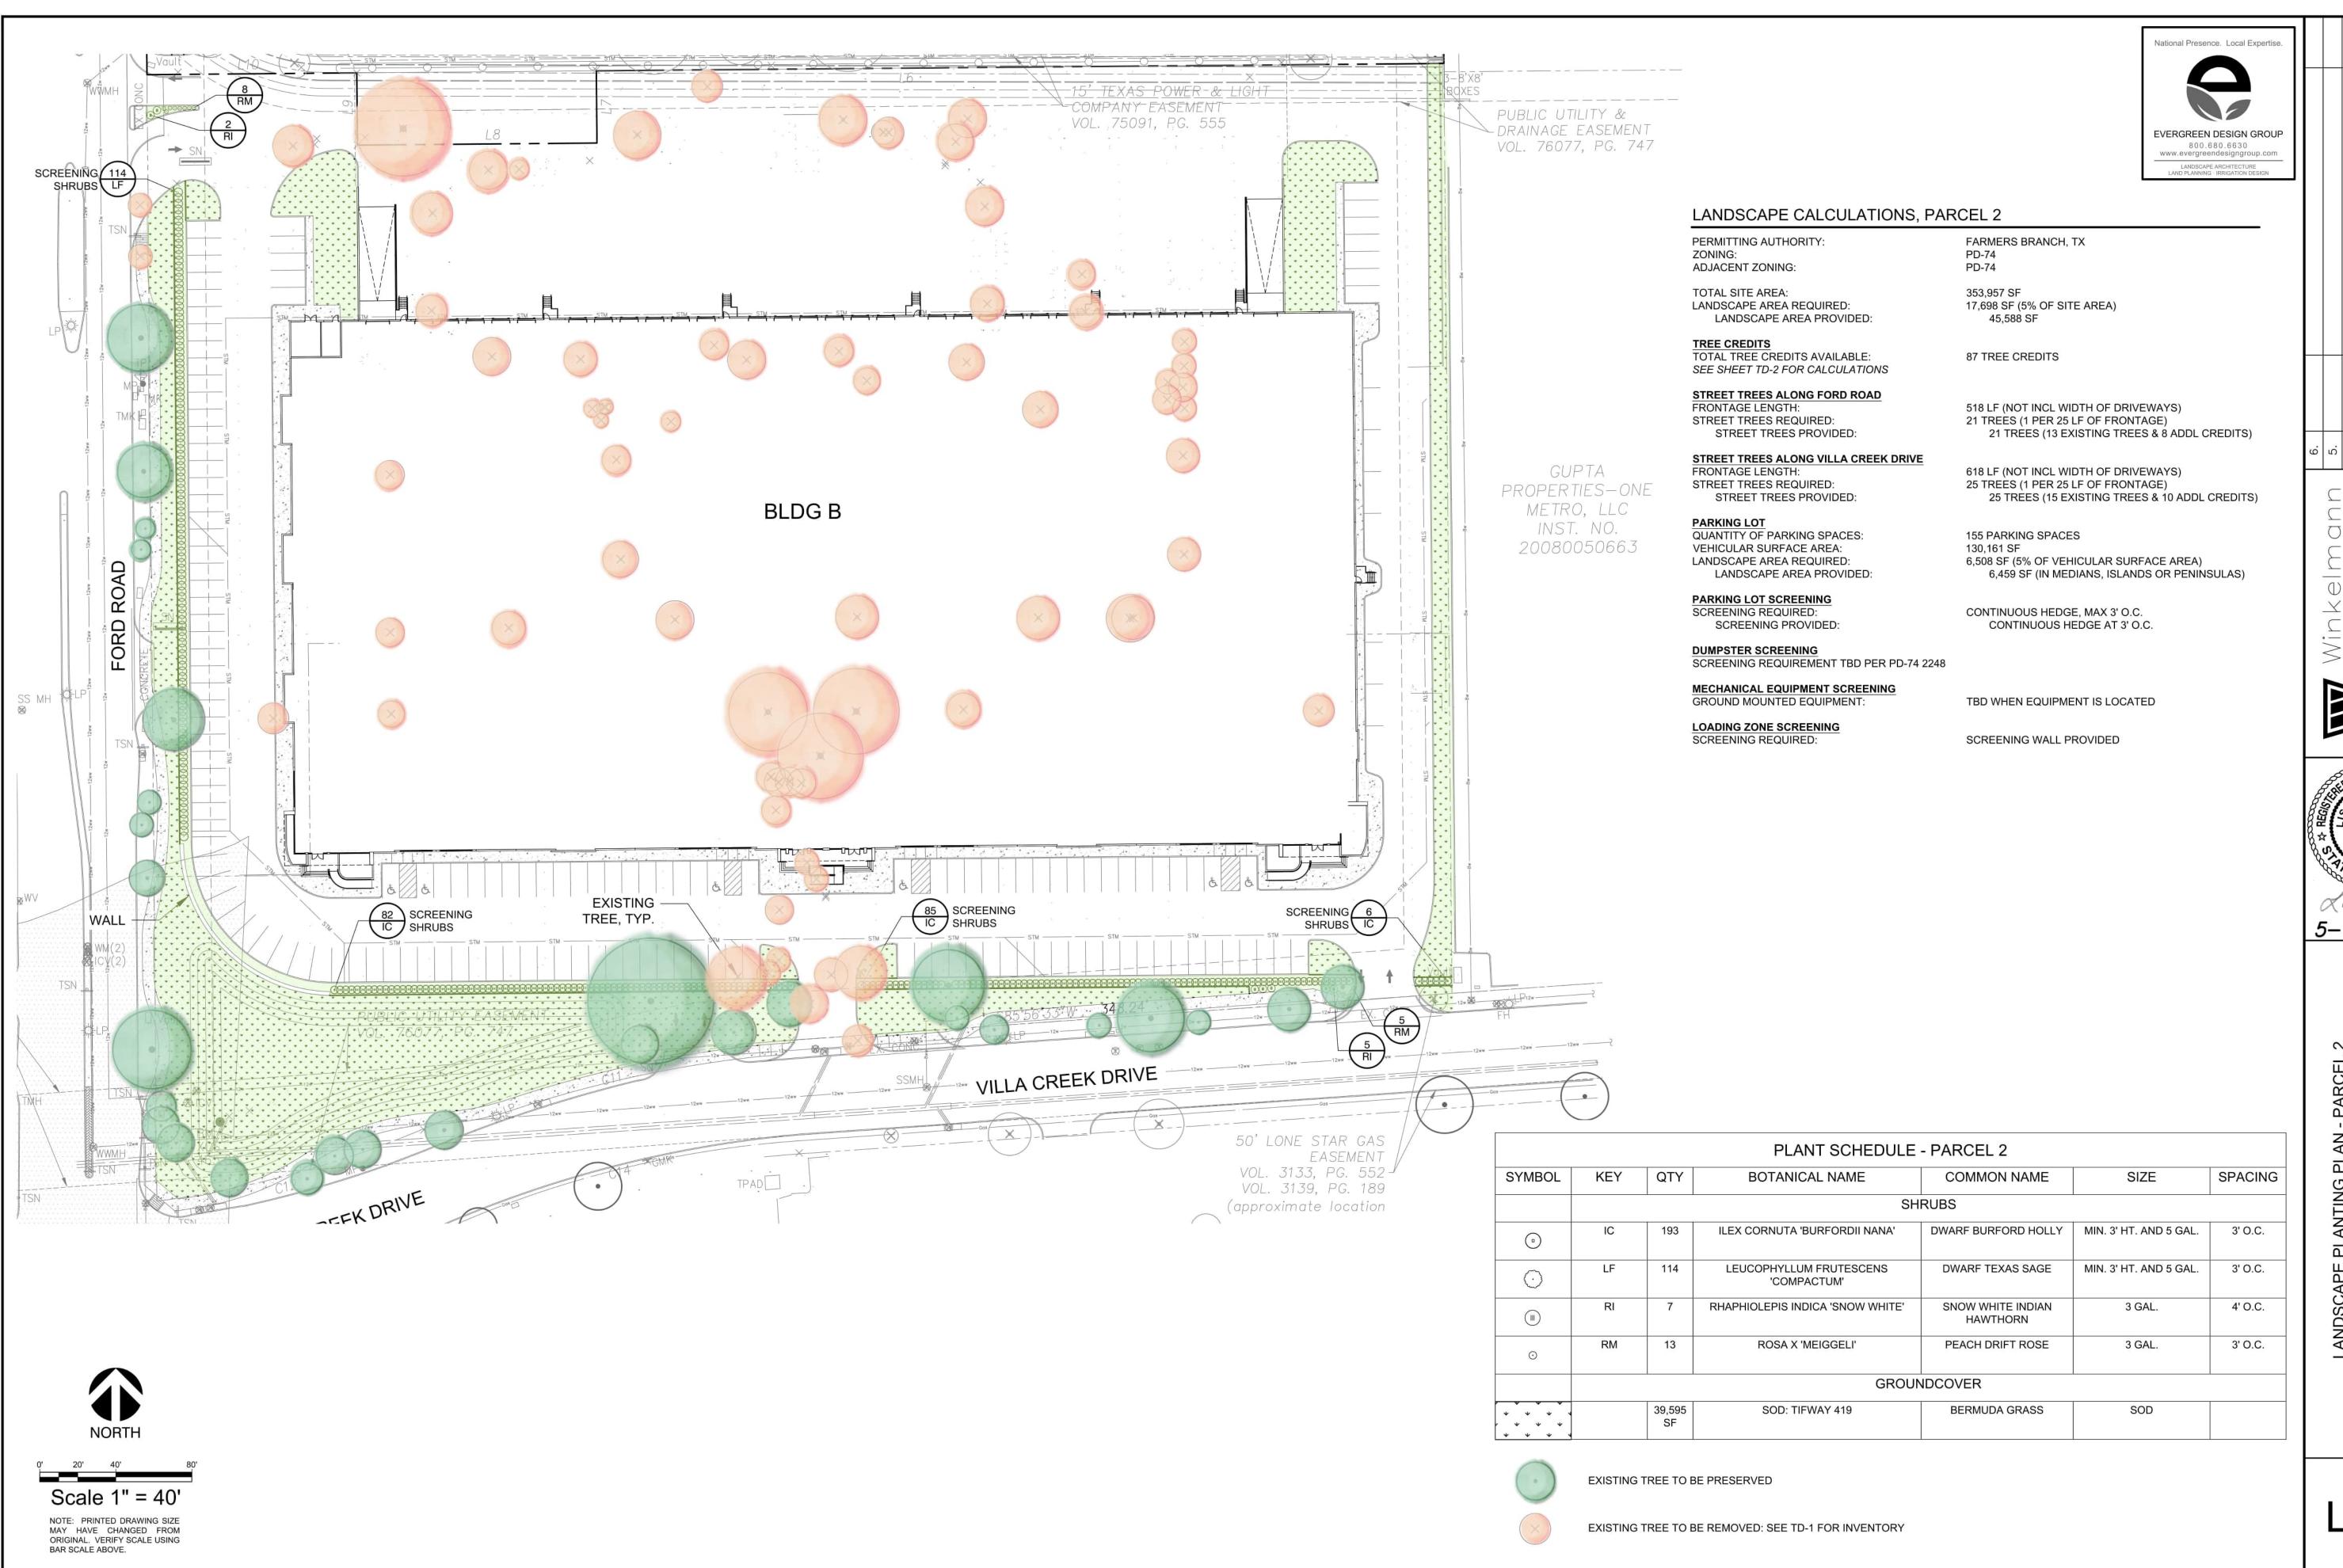


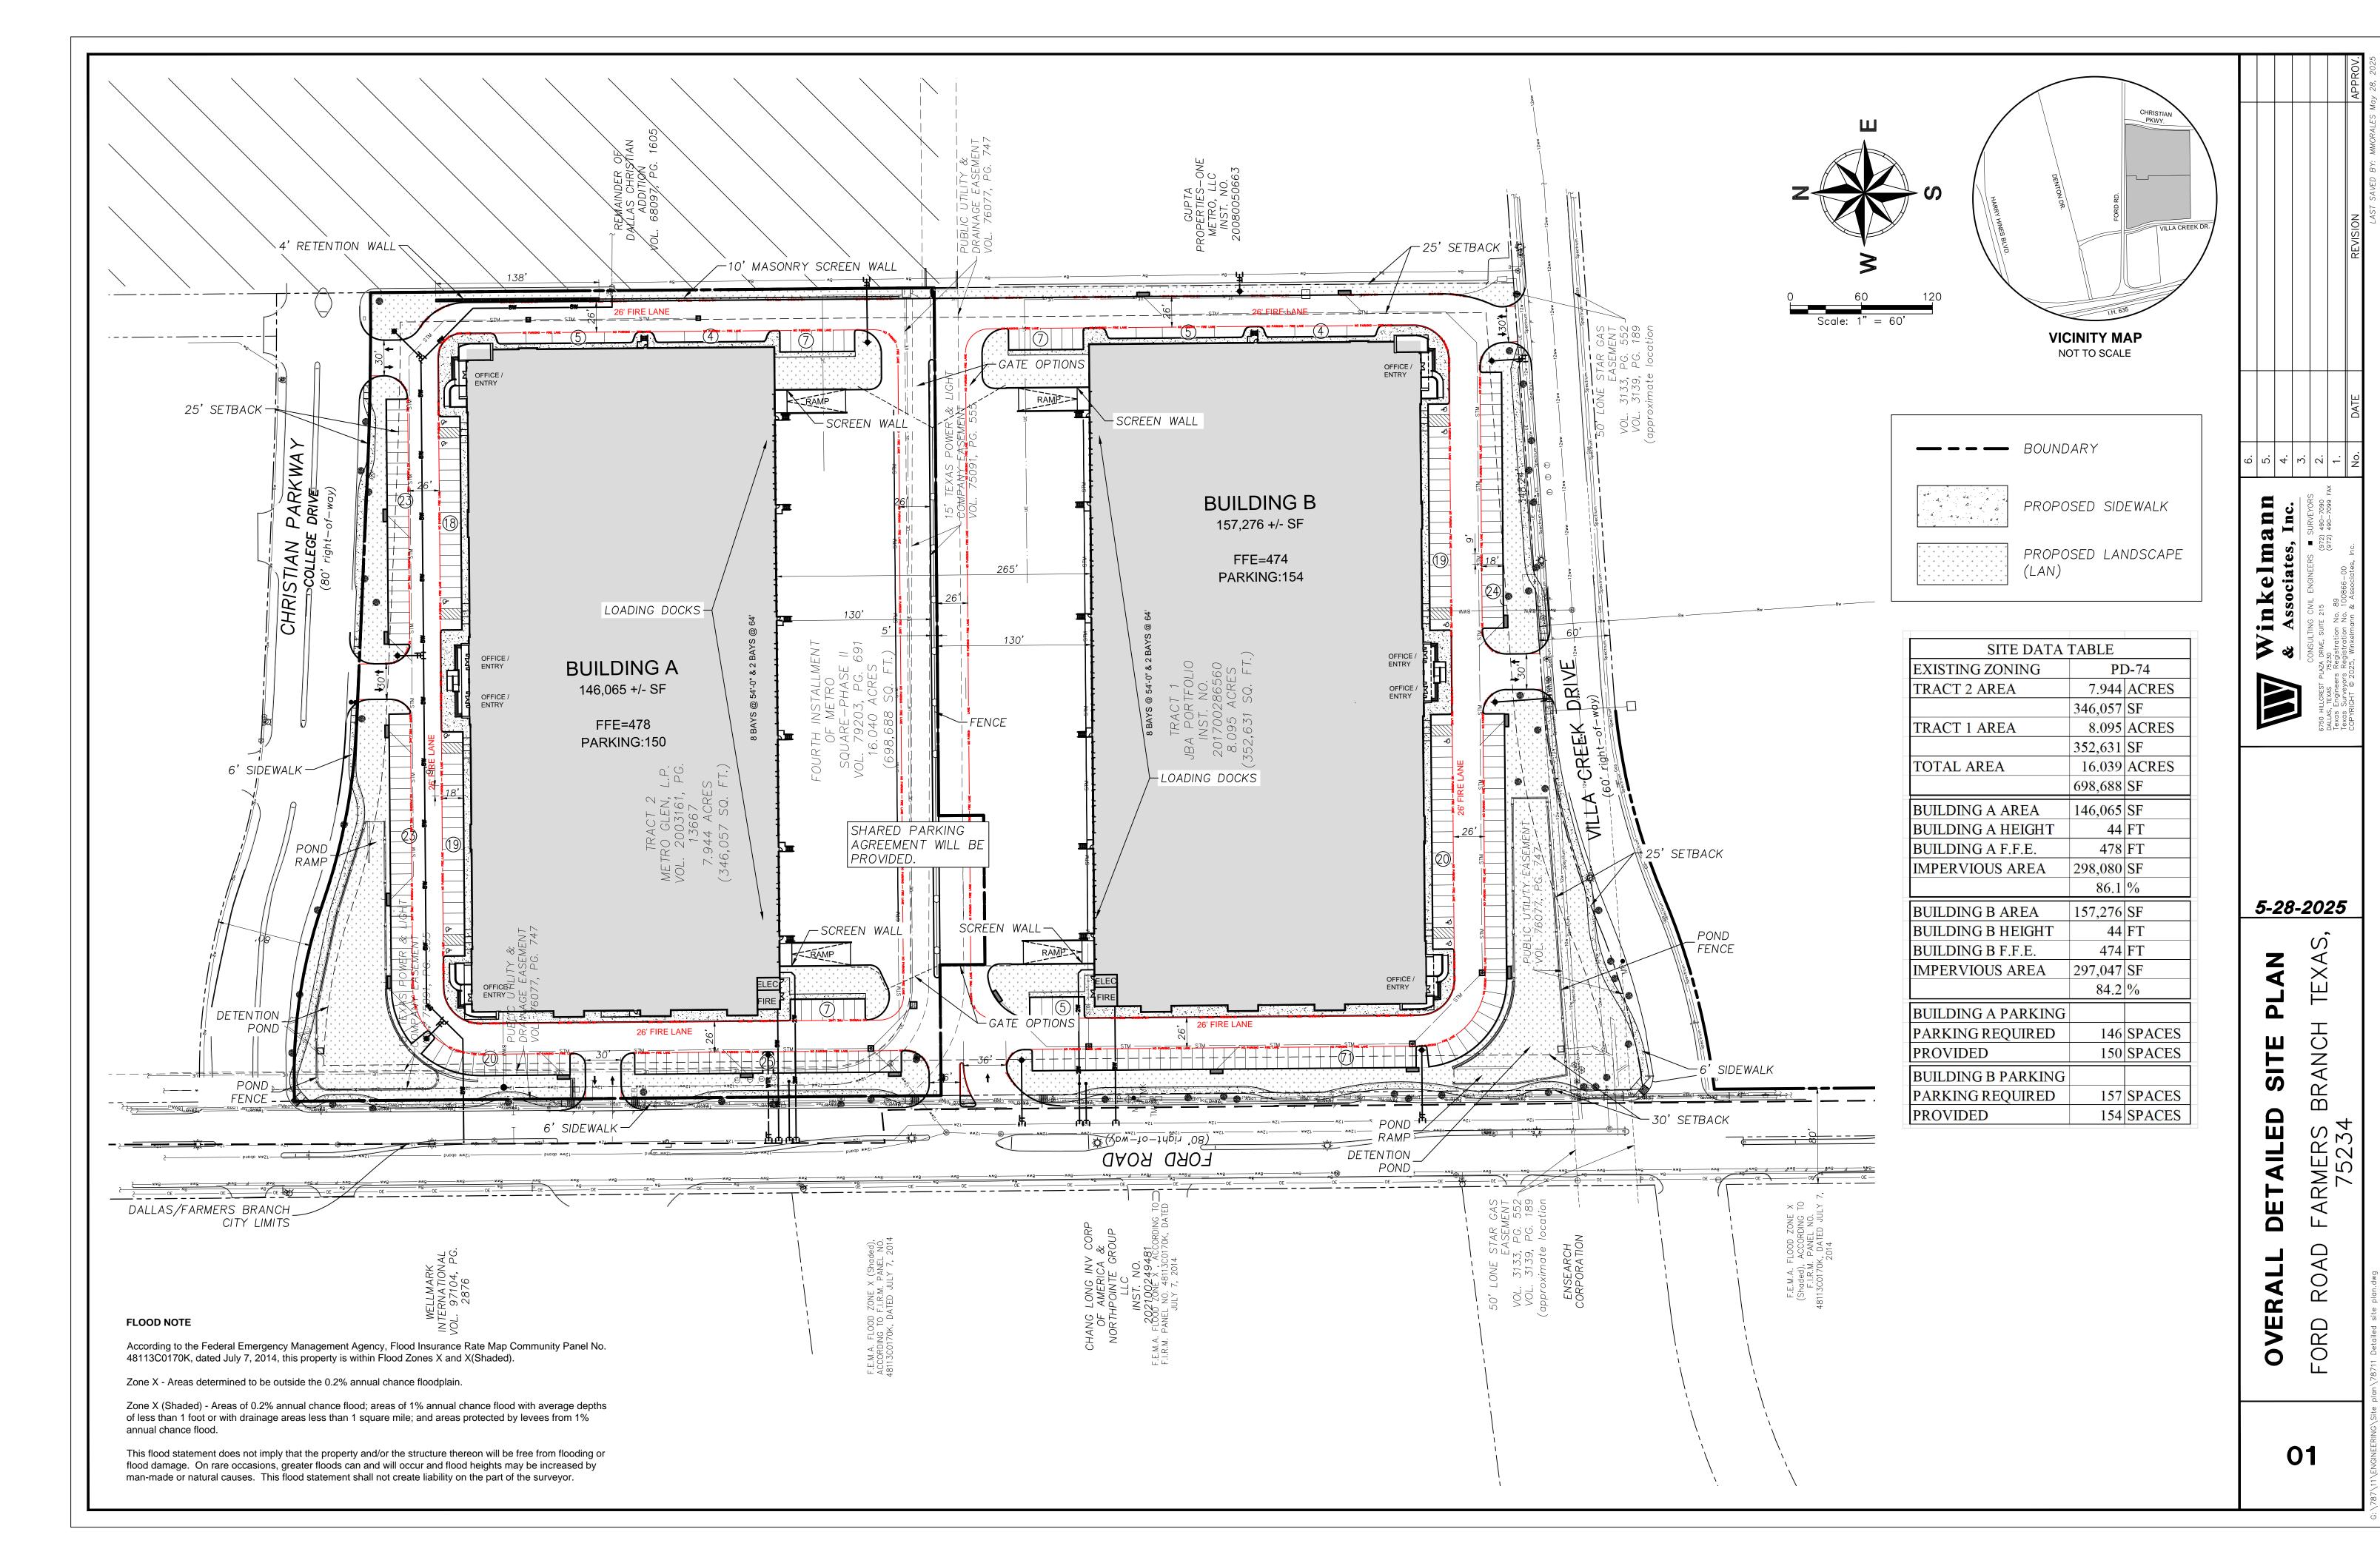Scale 1" = 40'

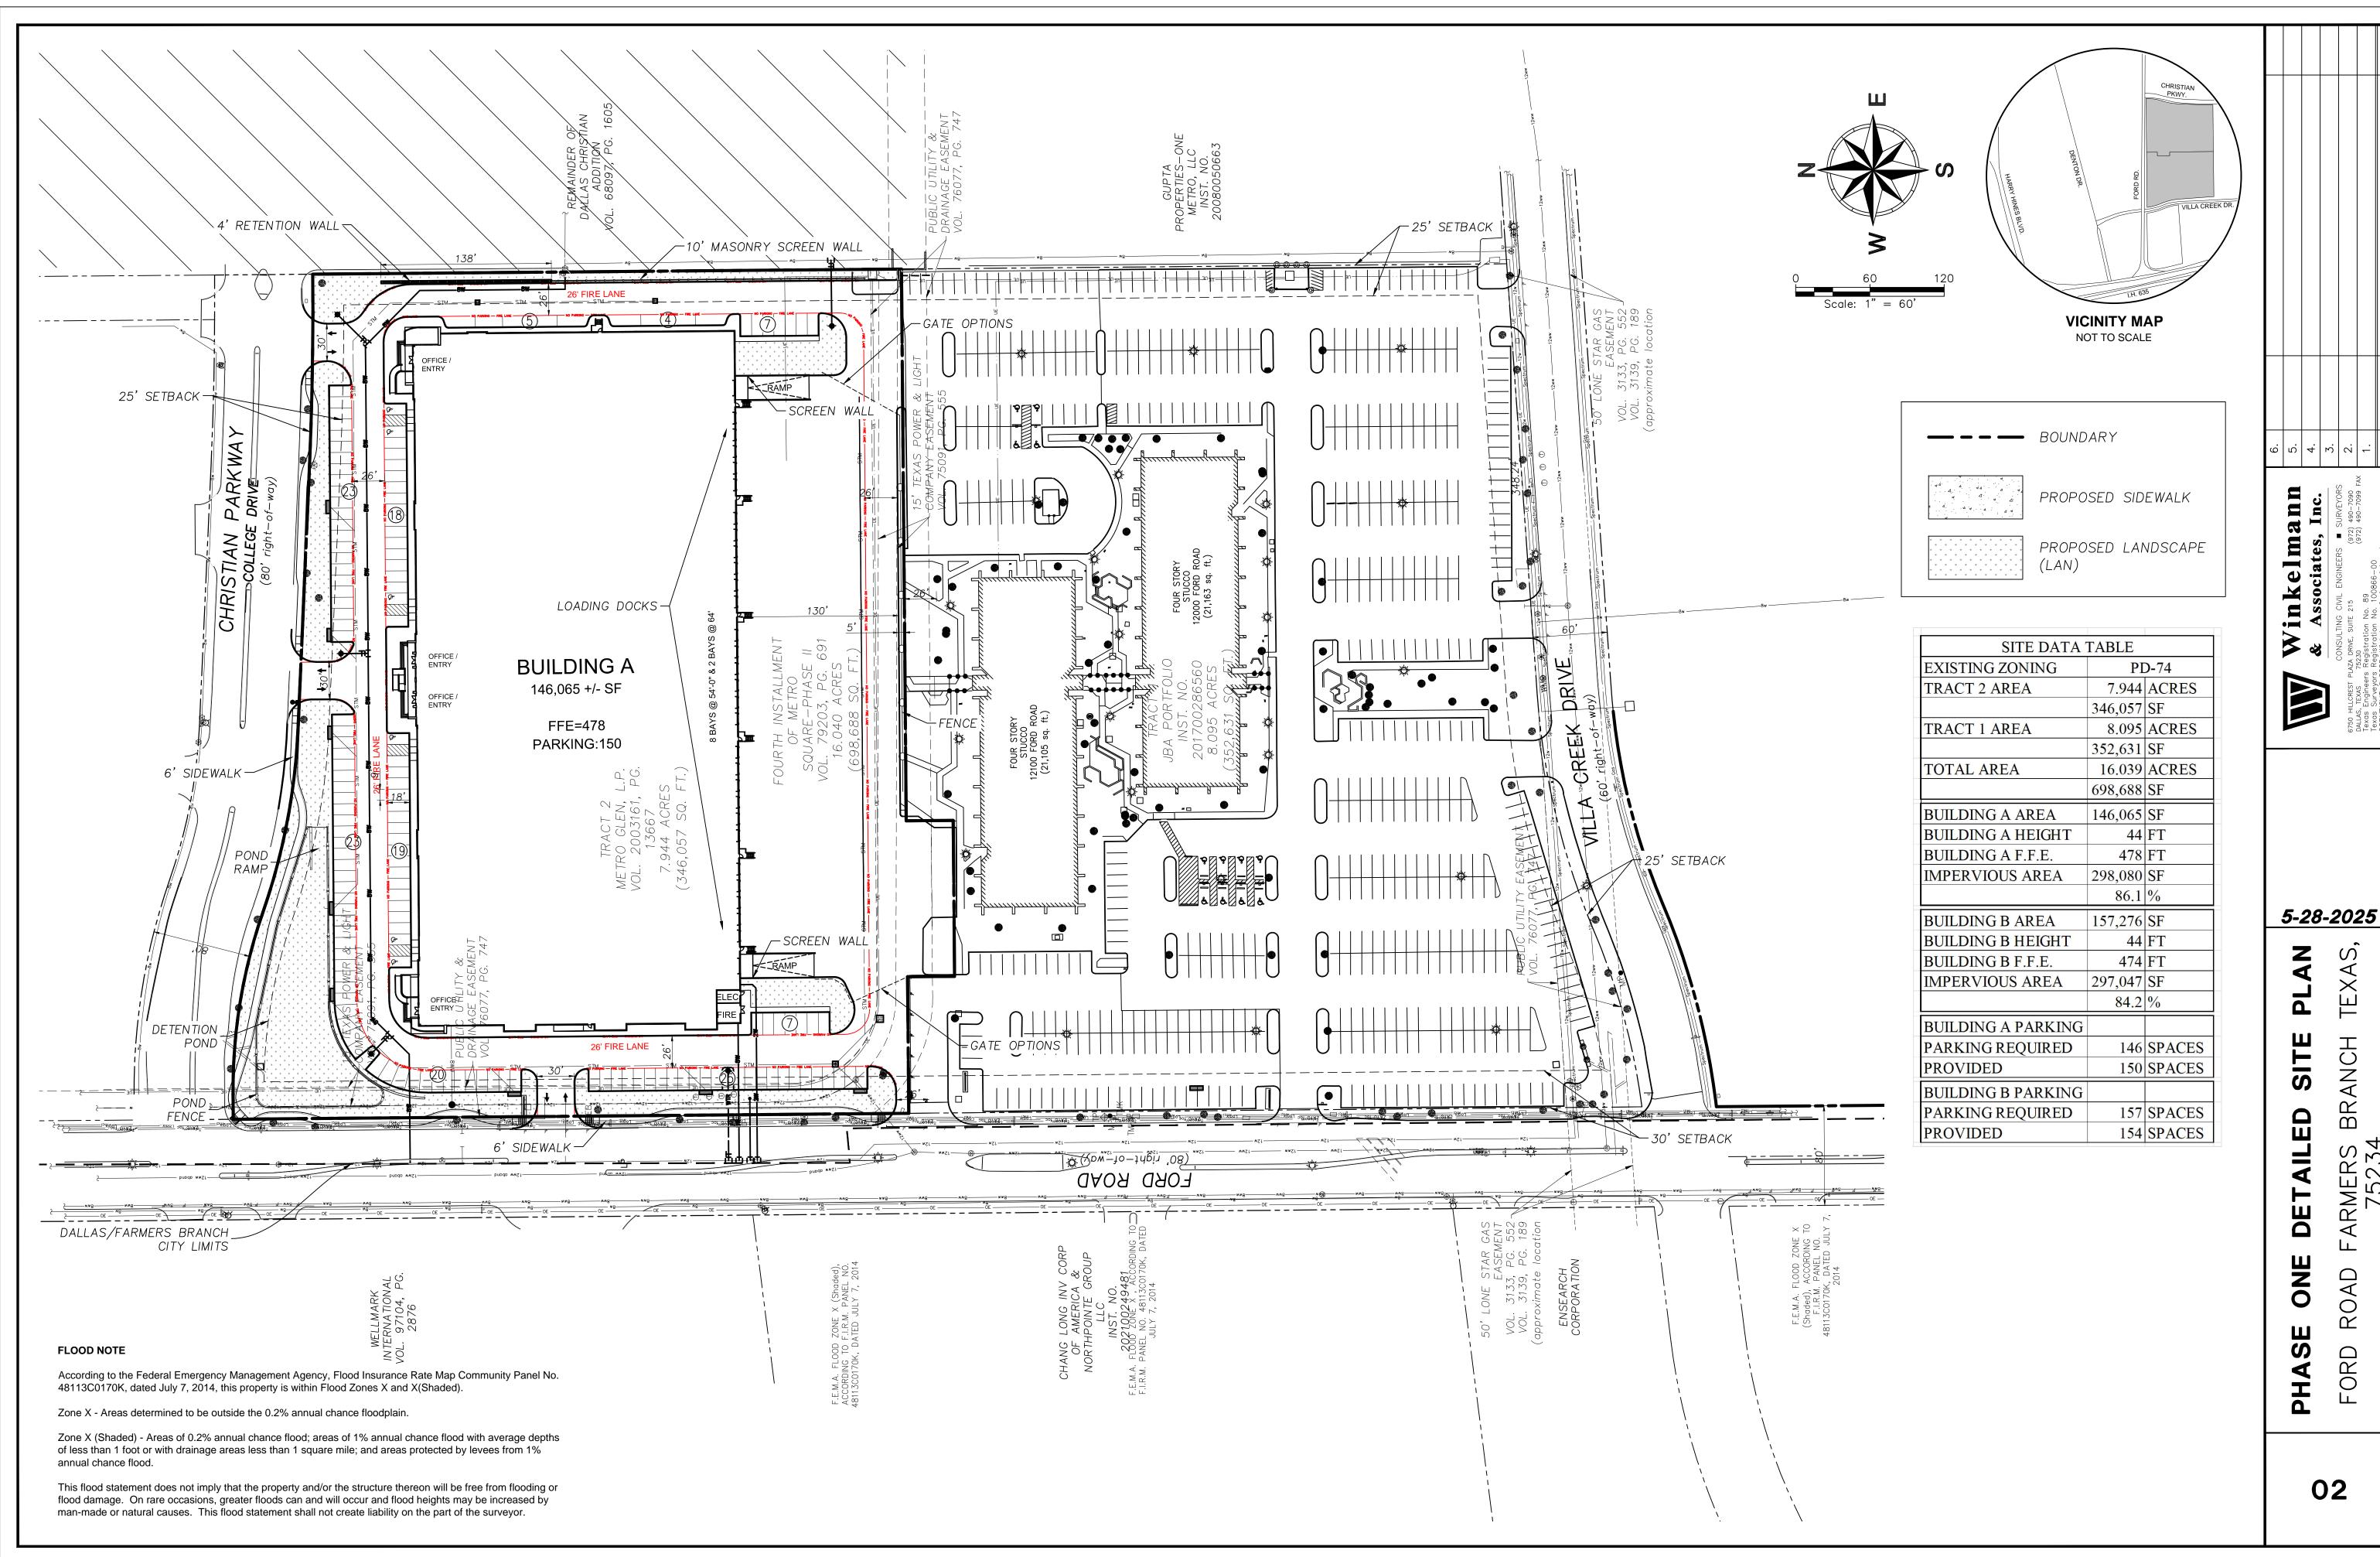NOTE: PRINTED DRAWING SIZE MAY HAVE CHANGED FROM ORIGINAL. VERIFY SCALE USING

BAR SCALE ABOVE.

LP-1




5-12-2025

BRANCH

RO ORD

LP-2

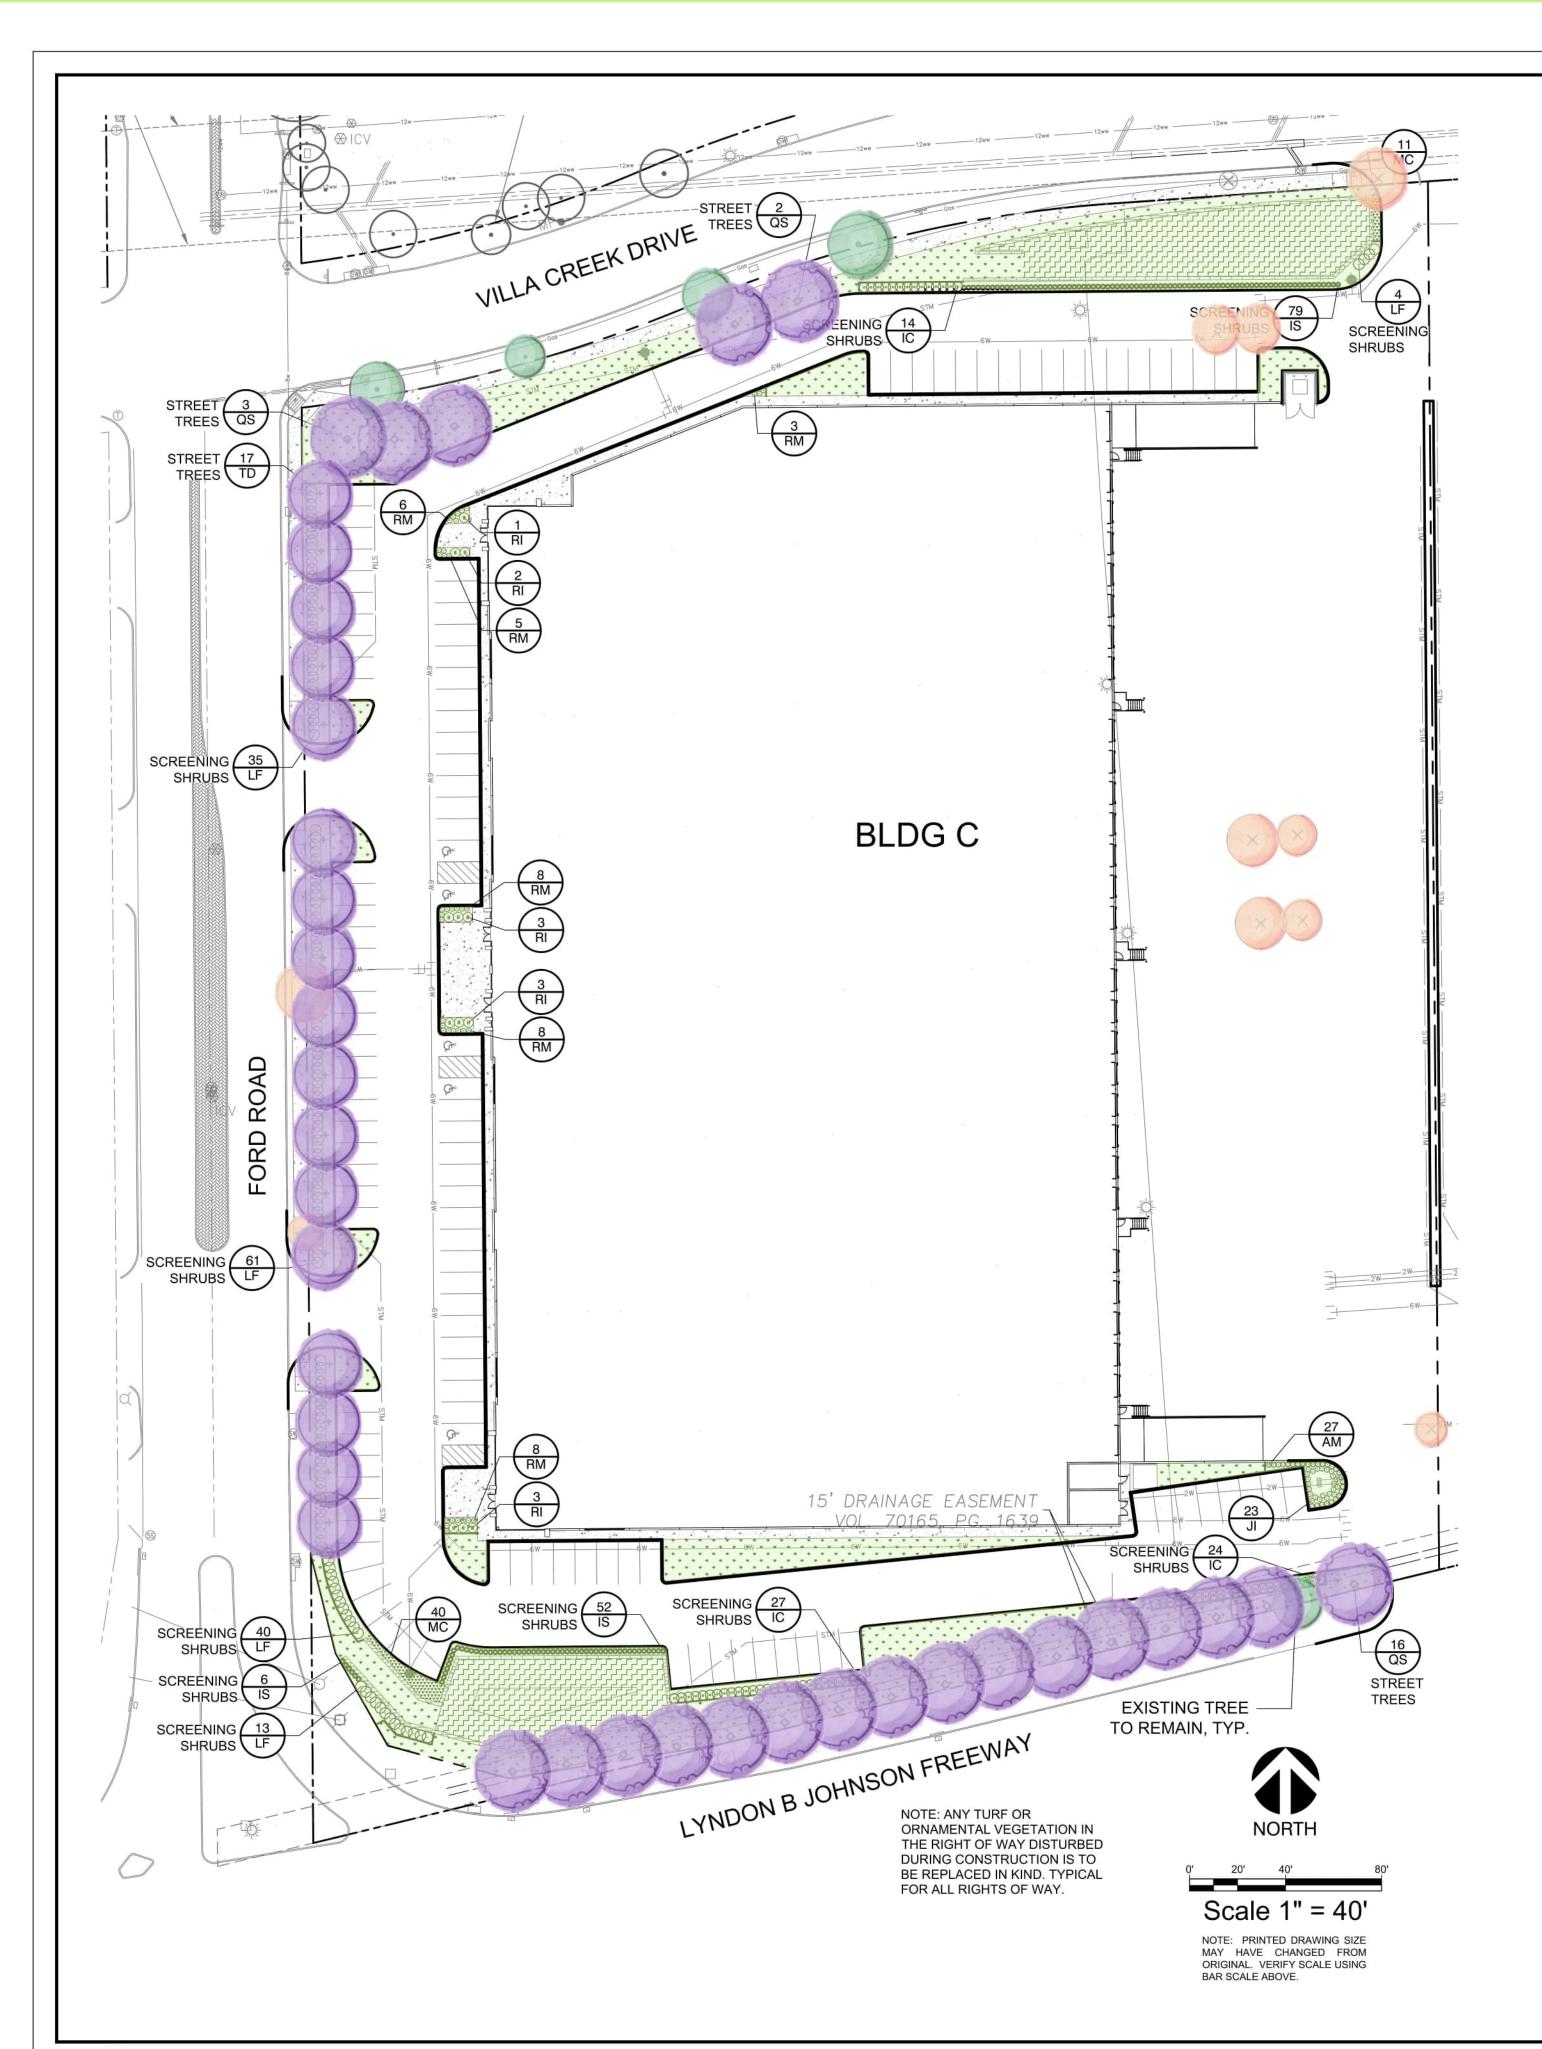

LANDSCAPE CALCULATIONS, PARCEL C

FARMERS BRANCH, TX PERMITTING AUTHORITY: PD-74

ZONING: ADJACENT ZONING: PD-74

TOTAL SITE AREA: 281,094 SF LANDSCAPE AREA REQUIRED: 14,055 SF (5% OF SITE AREA)

LANDSCAPE AREA PROVIDED: 33,983 SF

TREE CREDITS TOTAL TREE CREDITS AVAILABLE:

STREET TREES ALONG FORD ROAD

SEE SHEET TD-1 FOR CALCULATIONS

FRONTAGE LENGTH: 443 LF (NOT INCL WIDTH OF DRIVEWAYS) 18 TREES (1 PER 25 LF OF FRONTAGE) STREET TREES REQUIRED: 18 TREES (17 PROPOSED & 1 CREDITS) STREET TREES PROVIDED:

15 TREE CREDITS

STREET TREES ALONG VILLA CREEK DRIVE

482 LF (NOT INCL WIDTH OF DRIVEWAYS) FRONTAGE LENGTH: STREET TREES REQUIRED: 19 TREES (1 PER 25 LF OF FRONTAGE) STREET TREES PROVIDED: 19 TREES (5 PROPOSED & 14 CREDITS)

STREET TREES ALONG LYNDON B JOHNSON FREEWAY

FRONTAGE LENGTH: 402 LF (NOT INCL WIDTH OF DRIVEWAYS) STREET TREES REQUIRED: 16 TREES (1 PER 25 LF OF FRONTAGE) 16 TREES

STREET TREES PROVIDED:

PARKING LOT QUANTITY OF PARKING SPACES: 117 PARKING SPACES

VEHICULAR SURFACE AREA: 113,669 SF

LANDSCAPE AREA REQUIRED: 5,683 SF (5% OF VEHICULAR SURFACE AREA) LANDSCAPE AREA PROVIDED: 4,996 SF (IN MEDIANS, ISLANDS OR PENINSULAS)

PARKING LOT SCREENING

SCREENING REQUIRED: CONTINUOUS HEDGE, MAX 3' O.C. CONTINUOUS HEDGE AT 3' O.C. SCREENING PROVIDED:

NOTE: SKY PENCIL HOLLY IS PROPOSED FOR AREAS TOO NARROW TO PLANT THE VARIETIES SHOWN ON THE PLANT LIST IN THE PD ORDINANCE. THE ONLY NARROW SHRUB OFFERED IN THE ORDINANCE IS NANDINA, BUT IT IS CONSIDERED INVASIVE. SKY PENCIL HOLLY IS OFFERED AS A NON-INVASIVE ALTERNATIVE.

DUMPSTER SCREENING

SCREENING REQUIREMENT TBD PER PD-74 2248

MECHANICAL EQUIPMENT SCREENING GROUND MOUNTED EQUIPMENT:

TBD WHEN EQUIPMENT IS LOCATED

LOADING ZONE SCREENING

SCREENING REQUIRED: SCREENING WALL PROVIDED

			PLANT SCHEDULE	- PARCEL 1				
SYMBOL	KEY	QTY	BOTANICAL NAME	COMMON NAME	SIZE	SPACING		
			Т	REES				
0	QS	21	QUERCUS SHUMARDII	SHUMARD OAK	MIN. 2" CAL.	PER PLAN		
0	TD	17	TAXODIUM DISTICHUM	BALDCYPRESS	MIN. 2" CAL.	PER PLAN		
			SH	IRUBS				
0					ARONIA MELANOCARPA 'LOW SCAPE MOUND'	LOW SCAPE MOUND CHOKEBERRY	3 GAL.	2' O.C.
0	IC	180	ILEX CORNUTA 'BURFORDII NANA'	ILEX CORNUTA 'BURFORDII NANA' DWARF BURFORD HOLLY MIN. 3' HT. AND 5 GAL. LUECOPHYLLUM FRUTESCENS 'COMPACTUM' MIN. 3' HT. AND 5 GAL.		3' O.C.		
0	LF	123				3' O.C.		
0	IS	99	ILEX CRENATA 'SKY PENCIL'	SKY PENCIL HOLLY	MIN. 3' HT. AND 5 GAL.	2' O.C.		
(II)	RI	12	RHAPHIOLEPIS INDICA 'SNOW WHITE'	SNOW WHITE INDIAN HAWTHORN	3 GAL.	4' O.C.		
0	RM	32	ROSA X 'MEIGGELI'	PEACH DRIFT ROSE	3 GAL.	3' O.C.		
			GROU	NDCOVER				
0	JI	23	JUNCUS INFLEXUS 'BLUE ARROWS'	BLUE ARROWS RUSH	1 GAL.	2' O.C.		
0 0 0 0 0 0 0 0 0 0 0 0 0 0 0 0 0 0 0	MC	51	MUHLENBERGIA CAPILLARIS	PINK MUHLY GRASS	PLUGS	30" O.C.		
+ + + + + + + + + + + + + + + + + + +		16,829 SF	SOD: TIFWAY 419	BERMUDA GRASS	SOD			
		6,533	HYDROMULCH TURF	SEE SPECS FOR S	SEED MIX AND SEEDING R	ATE		



EXISTING TREE TO BE PRESERVED



EXISTING TREE TO BE REMOVED: SEE TD-1 FOR INVENTORY





5-11-2025

 \Box

BLD E $\ddot{\circ}$ OA BR,

P-1

BAR SCALE ABOVE.

LANDSCAPE CALCULATIONS, PARCEL D

PERMITTING AUTHORITY: FARMERS BRANCH, TX PD-74 ZONING:

ADJACENT ZONING: PD-74

233,055 SF TOTAL SITE AREA:

LANDSCAPE AREA REQUIRED: 11,653 SF (5% OF SITE AREA) LANDSCAPE AREA PROVIDED: 29,935 SF

TREE CREDITS

TOTAL TREE CREDITS AVAILABLE: 27 TREE CREDITS

SEE SHEET TD-2 FOR CALCULATIONS

STREET TREES ALONG VILLA CREEK DRIVE

FRONTAGE LENGTH: 369 LF (NOT INCL WIDTH OF DRIVEWAYS) STREET TREES REQUIRED: 15 TREES (1 PER 25 LF OF FRONTAGE) STREET TREES PROVIDED: 15 TREES (3 PROPOSED TREES & 15 CREDITS)

STREET TREES ALONG LYNDON B JOHNSON FREEWAY

382 LF (NOT INCL WIDTH OF DRIVEWAYS) FRONTAGE LENGTH: STREET TREES REQUIRED: 15 TREES (1 PER 25 LF OF FRONTAGE) STREET TREES PROVIDED: 15 TREES (15 CREDITS)

PARKING LOT

QUANTITY OF PARKING SPACES: 95 PARKING SPACES VEHICULAR SURFACE AREA:

LANDSCAPE AREA REQUIRED: 4,803 SF (5% OF VEHICULAR SURFACE AREA) LANDSCAPE AREA PROVIDED: 1,603 SF (IN MEDIANS, ISLANDS OR PENINSULAS)

PARKING LOT SCREENING

CONTINUOUS HEDGE, MAX 3' O.C. SCREENING REQUIRED: SCREENING PROVIDED: CONTINUOUS HEDGE AT 3' O.C.

DUMPSTER SCREENING

SCREENING REQUIREMENT TBD PER PD-74 2248

MECHANICAL EQUIPMENT SCREENING

GROUND MOUNTED EQUIPMENT: TBD WHEN EQUIPMENT IS LOCATED

LOADING ZONE SCREENING

SCREENING REQUIRED: SCREENING WALL PROVIDED

ROOT BARRIERS

THE CONTRACTOR SHALL INSTALL ROOT BARRIERS NEAR ALL NEWLY-PLANTED TREES THAT ARE LOCATED WITHIN FIVE (5) FEET OF PAVING OR CURBS. ROOT BARRIERS SHALL BE "CENTURY" OR "DEEP-ROOT" 24" DEEP PANELS (OR EQUAL). BARRIERS SHALL BE LOCATED IMMEDIATELY ADJACENT TO HARDSCAPE. INSTALL PANELS PER MANUFACTURER'S RECOMMENDATIONS. UNDER NO CIRCUMSTANCES SHALL THE CONTRACTOR USE ROOT BARRIERS OF A TYPE THAT COMPLETELY ENCIRCLE THE ROOTBALL.

MULCHES

AFTER ALL PLANTING IS COMPLETE, CONTRACTOR SHALL INSTALL 3" THICK LAYER OF 1-1/2" SHREDDED WOOD MULCH, NATURAL (UNDYED), OVER LANDSCAPE FABRIC IN ALL PLANTING AREAS (EXCEPT FOR TURF AND SEEDED AREAS). CONTRACTOR SHALL SUBMIT SAMPLES OF ALL MULCHES TO LANDSCAPE ARCHITECT AND OWNER FOR APPROVAL PRIOR TO CONSTRUCTION. ABSOLUTELY NO EXPOSED GROUND SHALL BE LEFT SHOWING ANYWHERE ON THE PROJECT AFTER MULCH HAS BEEN INSTALLED (SUBJECT TO THE CONDITIONS AND REQUIREMENTS OF THE "GENERAL GRADING AND PLANTING NOTES" AND SPECIFICATIONS).

			PLANT SCHEDULE	- PARCEL 2		
SYMBOL	KEY	QTY	BOTANICAL NAME	COMMON NAME	SIZE	SPACING
			TI	REES	I	1
0	QS	3	QUERCUS SHUMARDII	SHUMARD OAK	MIN. 2" CAL.	PER PLAN
			SH	IRUBS	1	1
0	IC	123	ILEX CORNUTA 'BURFORDII NANA'	DWARF BURFORD HOLLY	MIN. 3' HT. AND 5 GAL.	3' O.C.
\odot	LF	46	LEUCOPHYLLUM FRUTESCENS 'COMPACTUM'	DWARF TEXAS SAGE	MIN. 3' HT. AND 5 GAL.	3' O.C.
(III)	RI	8	RHAPHIOLEPIS INDICA 'SNOW WHITE'	SNOW WHITE INDIAN HAWTHORN	3 GAL.	4' O.C.
0	RM	41	ROSA X 'MEIGGELI'	PEACH DRIFT ROSE	3 GAL.	3' O.C.
			GROUI	NDCOVER		1
* * * * * * * * * * * * * * * * * * *		21,134 SF	SOD: TIFWAY 419	BERMUDA GRASS	SOD	
		5,239 SF	HYDROMULCH TURF	SEE SPECS FOR S	SEED MIX AND SEEDING R	ATE



EXISTING TREE TO BE PRESERVED

EXISTING TREE TO BE REMOVED: SEE TD-1 FOR INVENTORY








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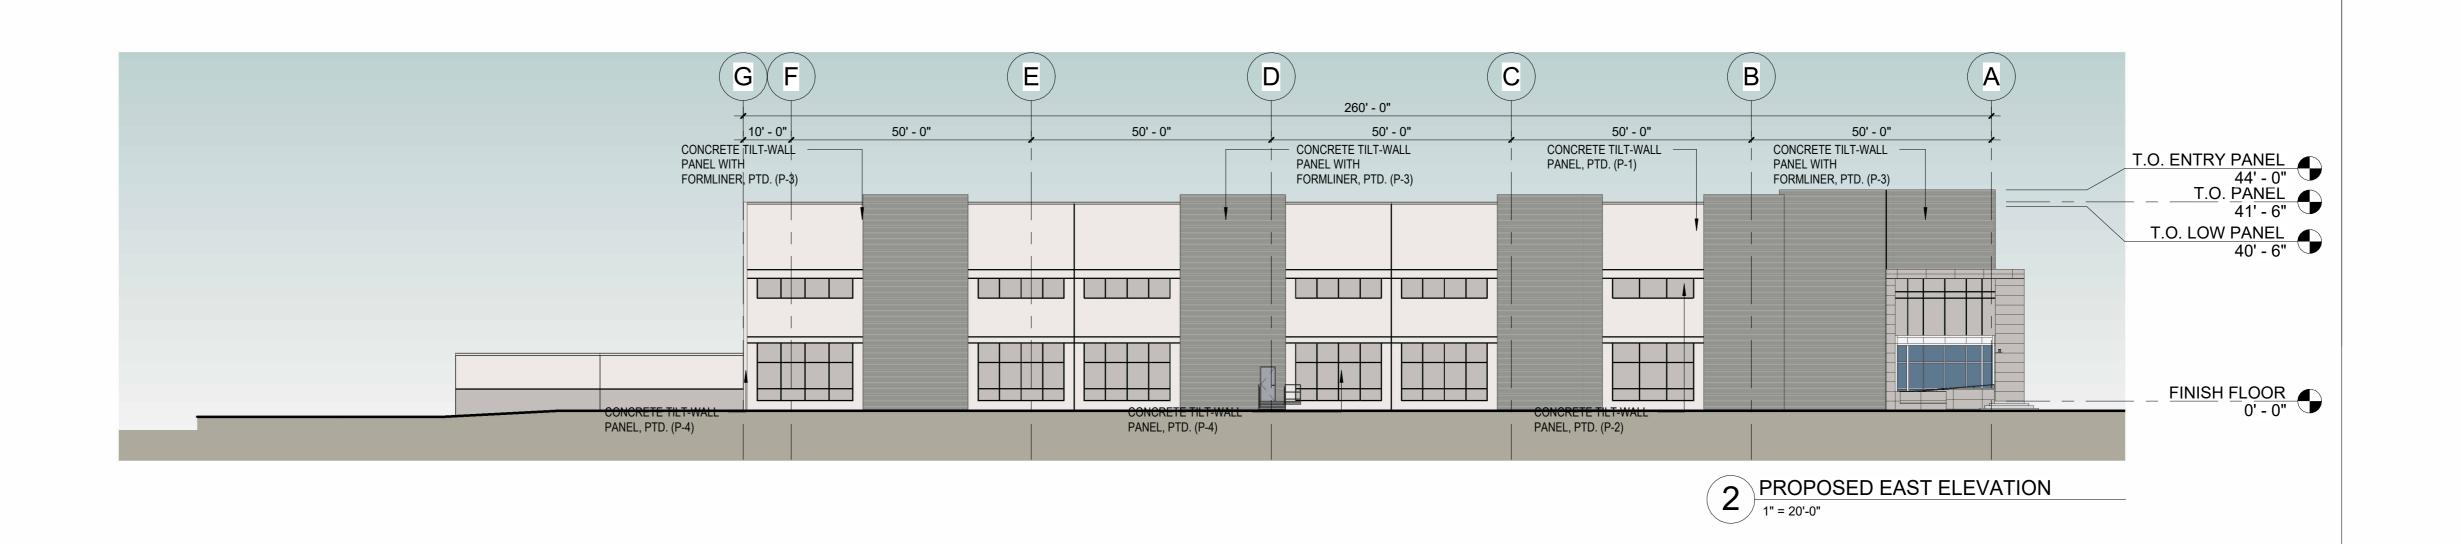
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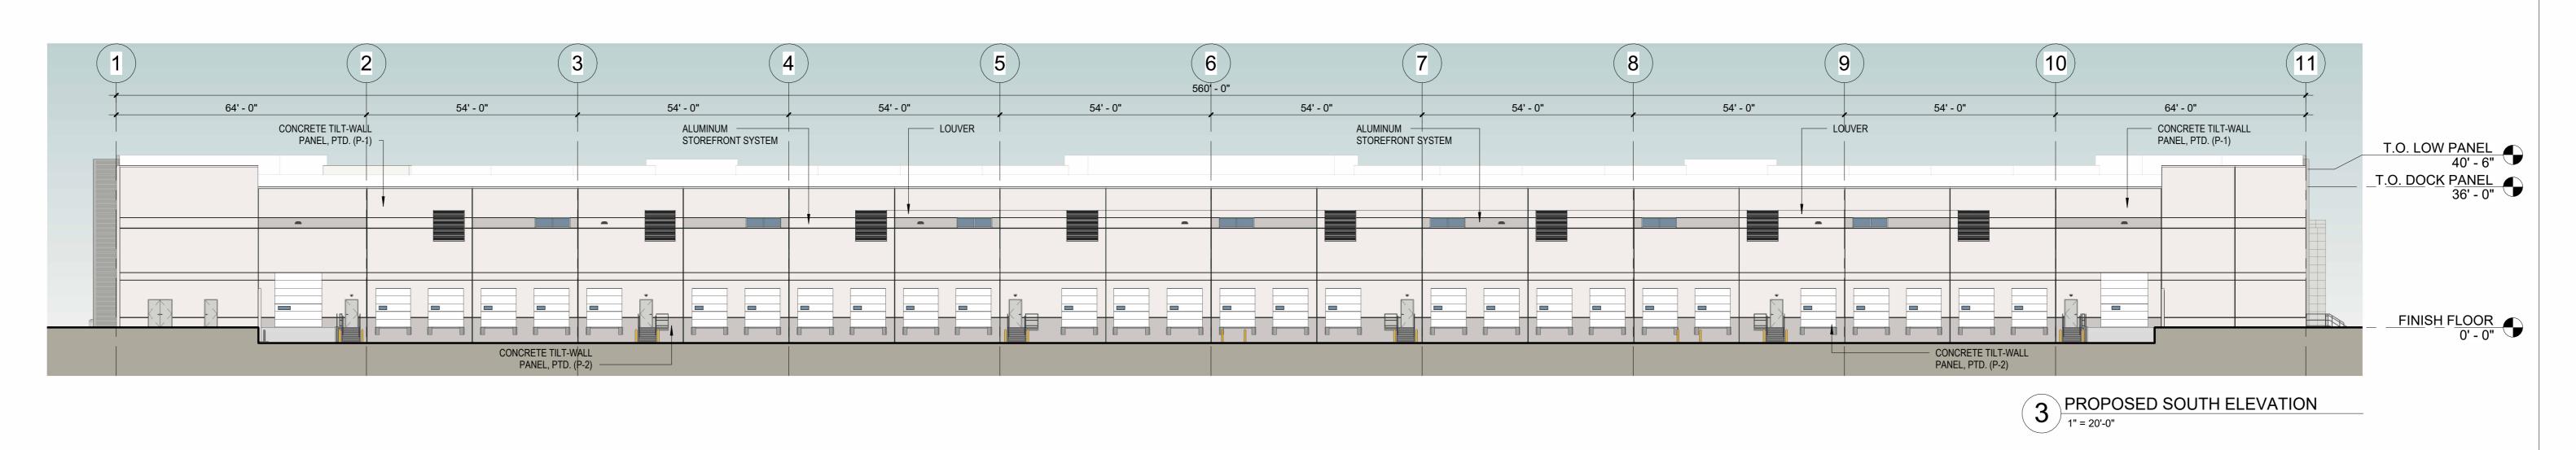
LP-2



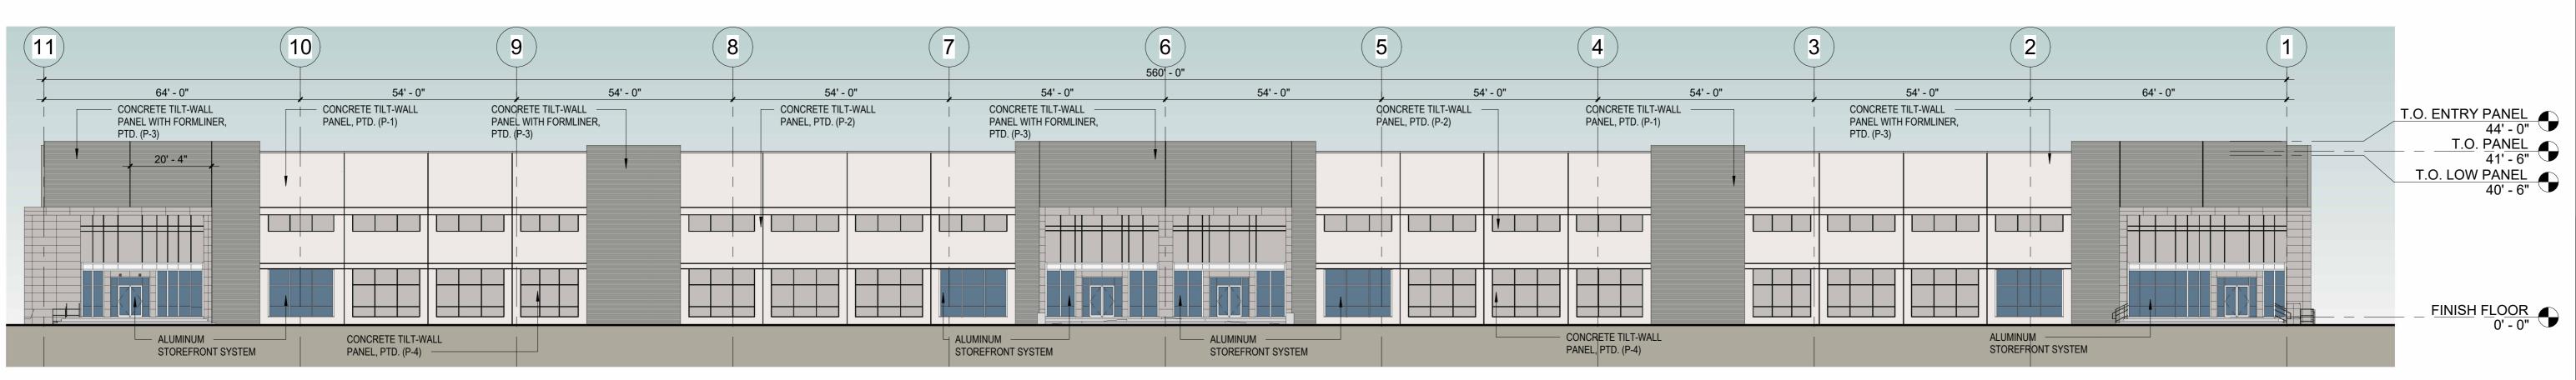

1 PROPOSED NORTH ELEVATION
1" = 20'-0"







REV.	DATE	ISSUE TITLE
	01/15/2024	CONCEPT DESIGN PACKAGE

A	C		E	FG	
FO! O"		260' - 0"	FO! O!	401 011	
50' - 0" CONCRETE TILT-WALL PANEL WITH FORMLINER, PTD. (P-3)	50' - 0" 50 CONCRETE TILT-WALL PANEL, PTD. (P-1)	- 0" 50' - 0" CONCRETE TILT-WALL PANEL WITH FORMLINER, PTD. (P-3)		10' - 0" CONCRETE TILT-WALL PANEL WITH FORMLINER, PTD. (P-3)	T.O. ENTRY PANEL 44' - 0' T.O. PANEL
•	•				41' - 6 T.O. LOW PANEL 40' - 6
	PANEL, PTD. (P-2)	ALUMINUM STOREFRONT SYSTEM	PANEL, PTD. (P-2)	PANEL, PTD. (P-4)	0 - 0


PROPOSED WEST ELEVATION

1" = 20'-0"

CONCEPT DESIGN PACKAGE - JANUARY 15, 2024

FORD ROAD
FARMERS BRANCH, TEXAS
PROPOSED ELEVATIONS
BUILDING A


SP-2.0
sheet number

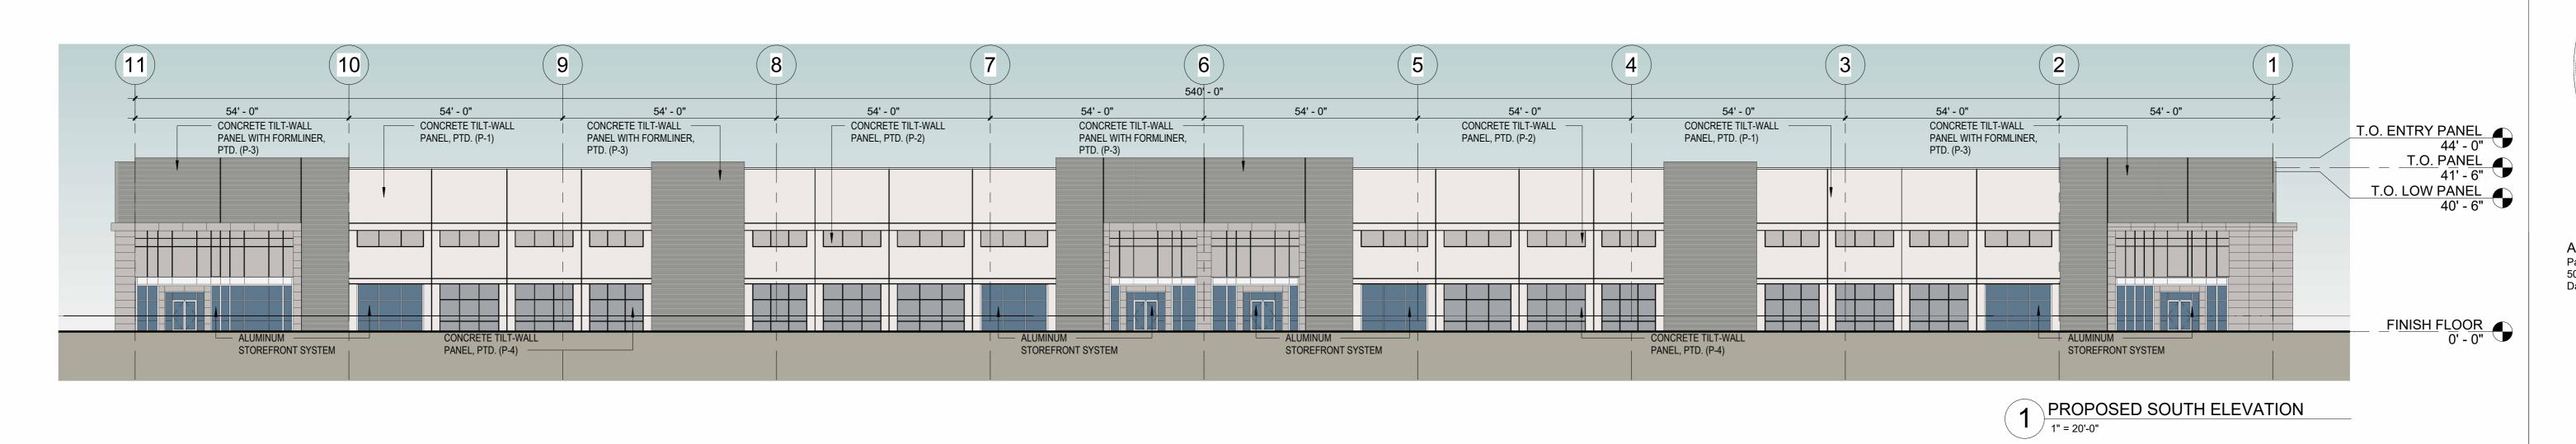




(D)280' - 0" 60' - 0" 55' - 0" 55' - 0" 55' - 0" 55' - 0" CONCRETE TILT-WALL — PANEL WITH FORMLINER, PTD. (P-3) CONCRETE TILT-WALL PANEL WITH CONCRETE TILT-WALL PANEL WITH CONCRETE TILT-WALL -PANEL, PTD. (P-1) T.O. ENTRY PANEL 44' - 0" FORMLINER, PTD. (P-3) FORMLINER, PTD. (P-3) T.O. PANEL 41' - 6" T.O. LOW PANEL 40' - 6" CONCRETE TILT-WALL PANEL, PTD. (P-2) STOREFRONT SYSTEM CONCRETE TILT-WALL – PANEL, PTD. (P-4) PROPOSED WEST ELEVATION

1" = 20'-0"

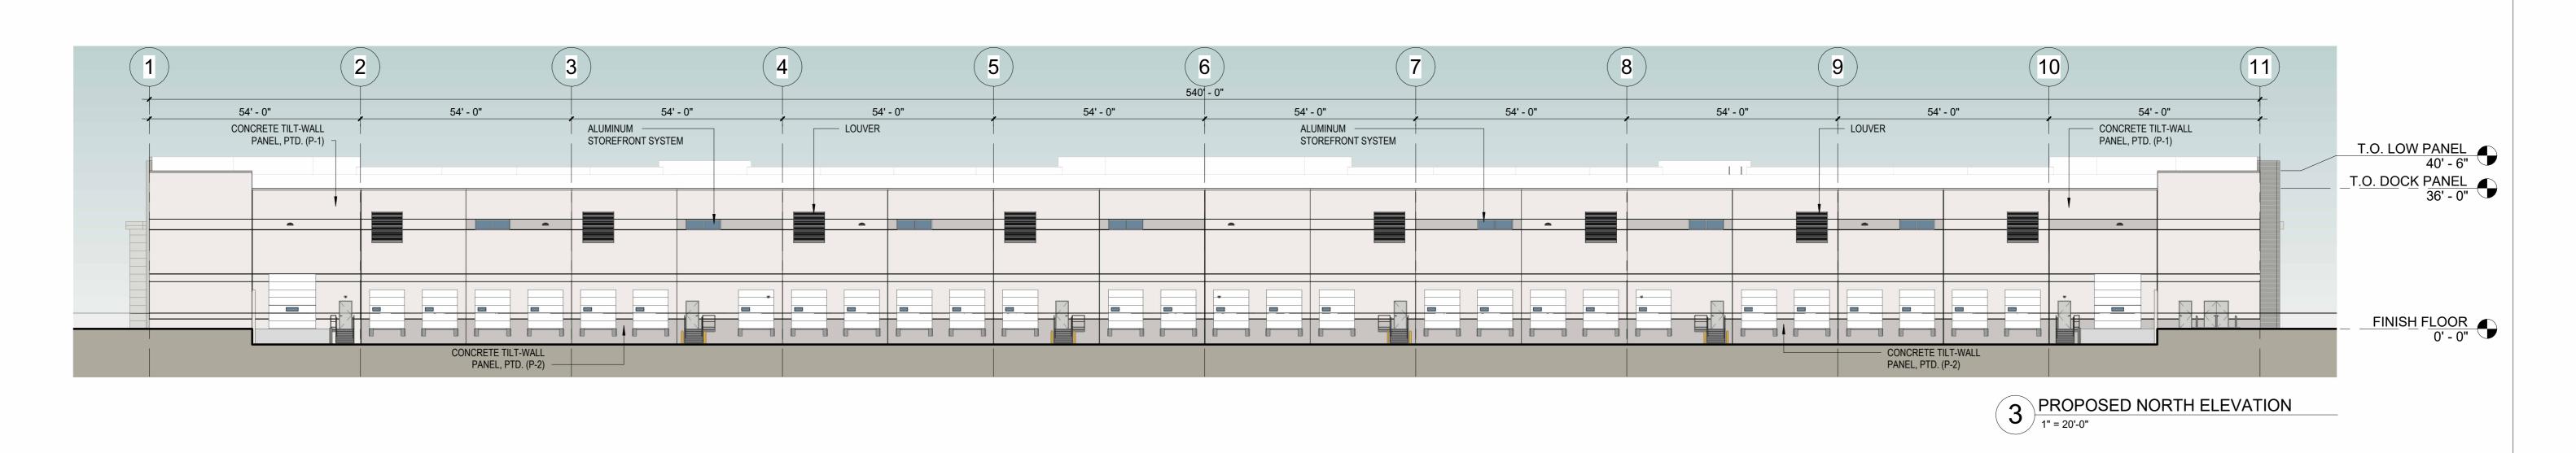

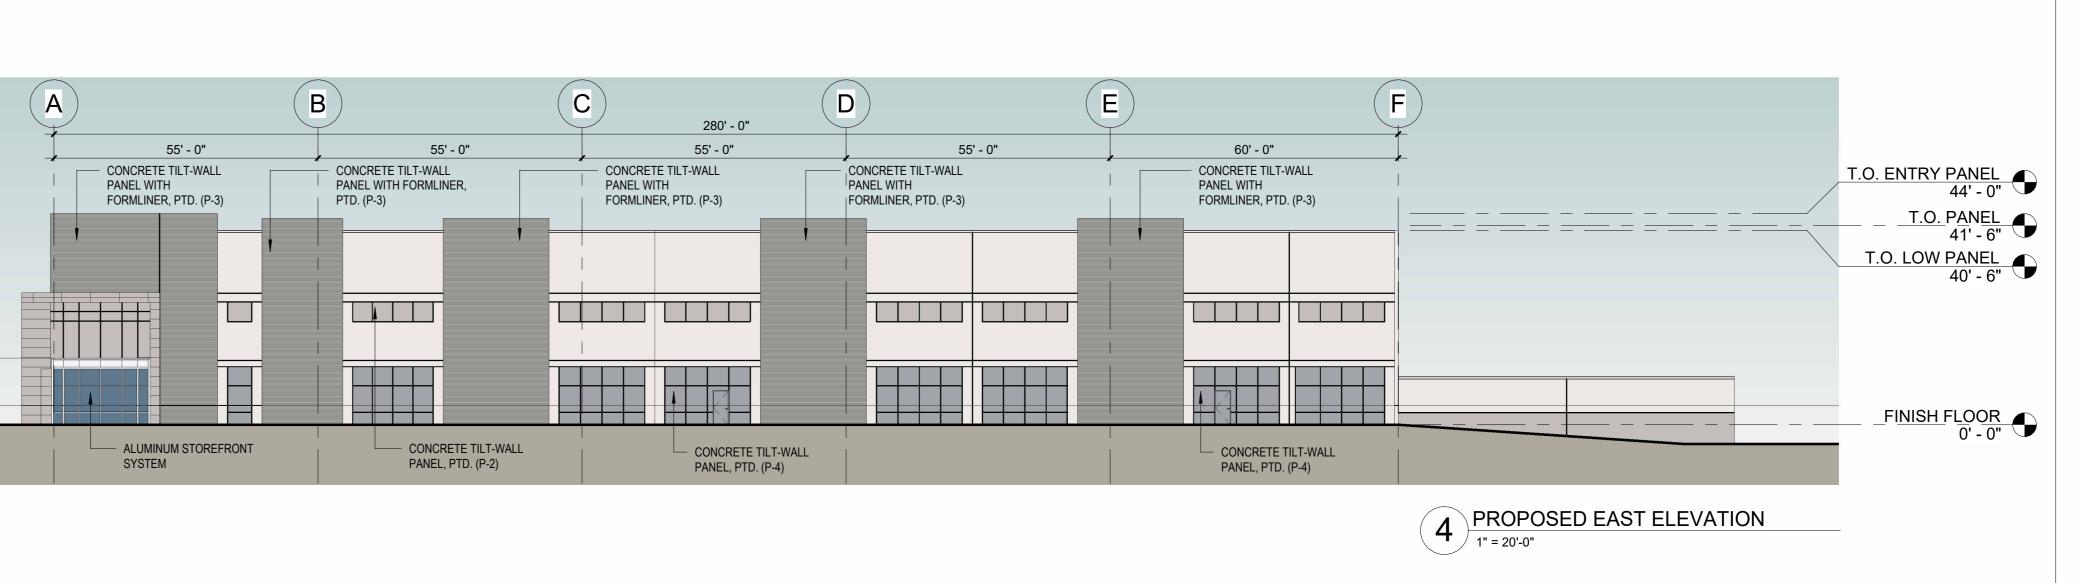


FORD ROAD
FARMERS BRANCH, TEXAS
PROPOSED ELEVATIONS
BUILDING B

01/15/2024 CONCEPT DESIGN PACKAGE

CONCEPT DESIGN PACKAGE - JANUARY 15, 2024


DIM2314
PROJECT NUMBER

DIM2514
SHEET NUMBER

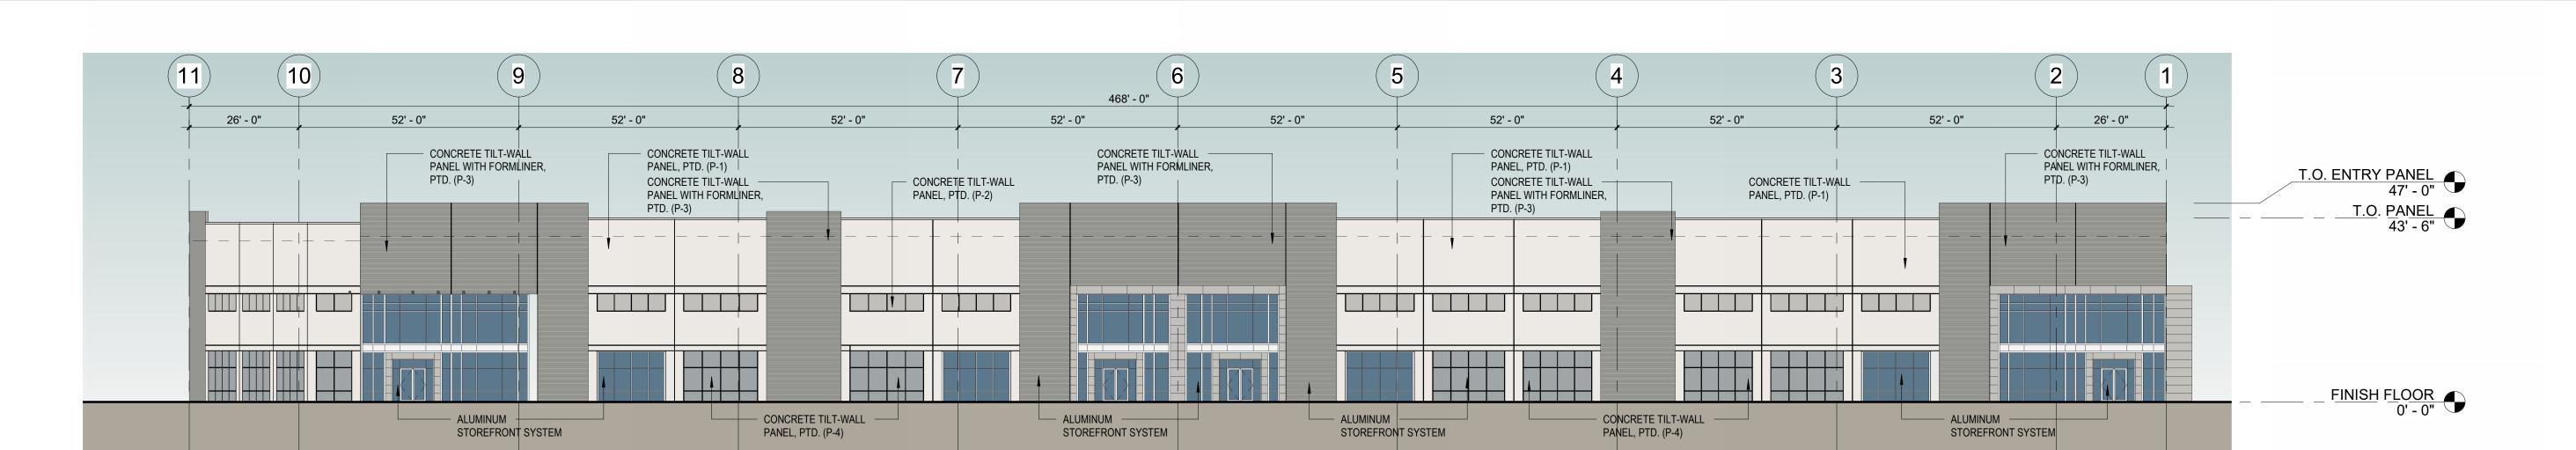


PROPOSED WEST ELEVATION

1" = 20'-0"

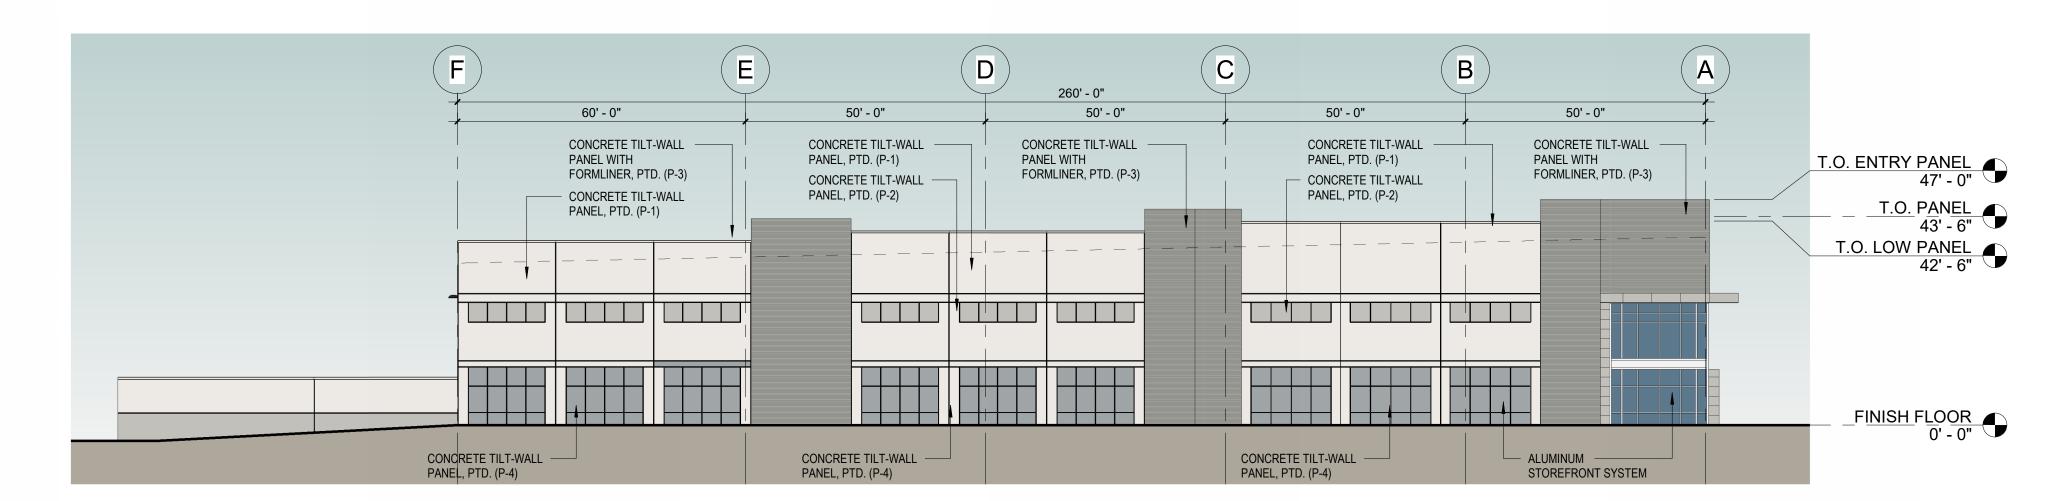


PROPOSED NORTH ELEVATION

1" = 20'-0"

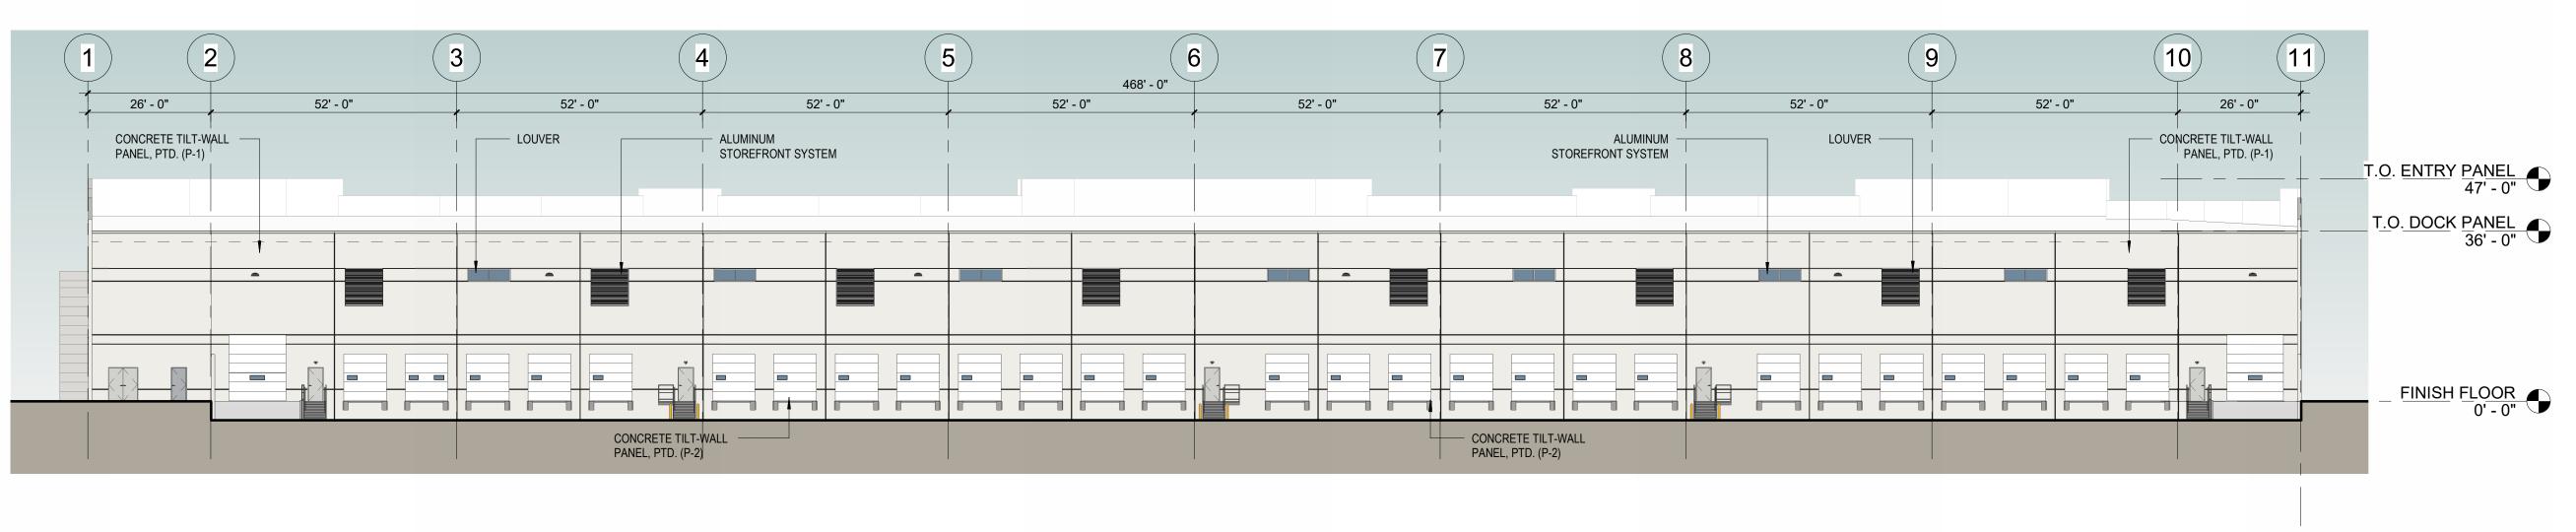

PROPOSED EAST ELEVATION

1" = 20'-0"

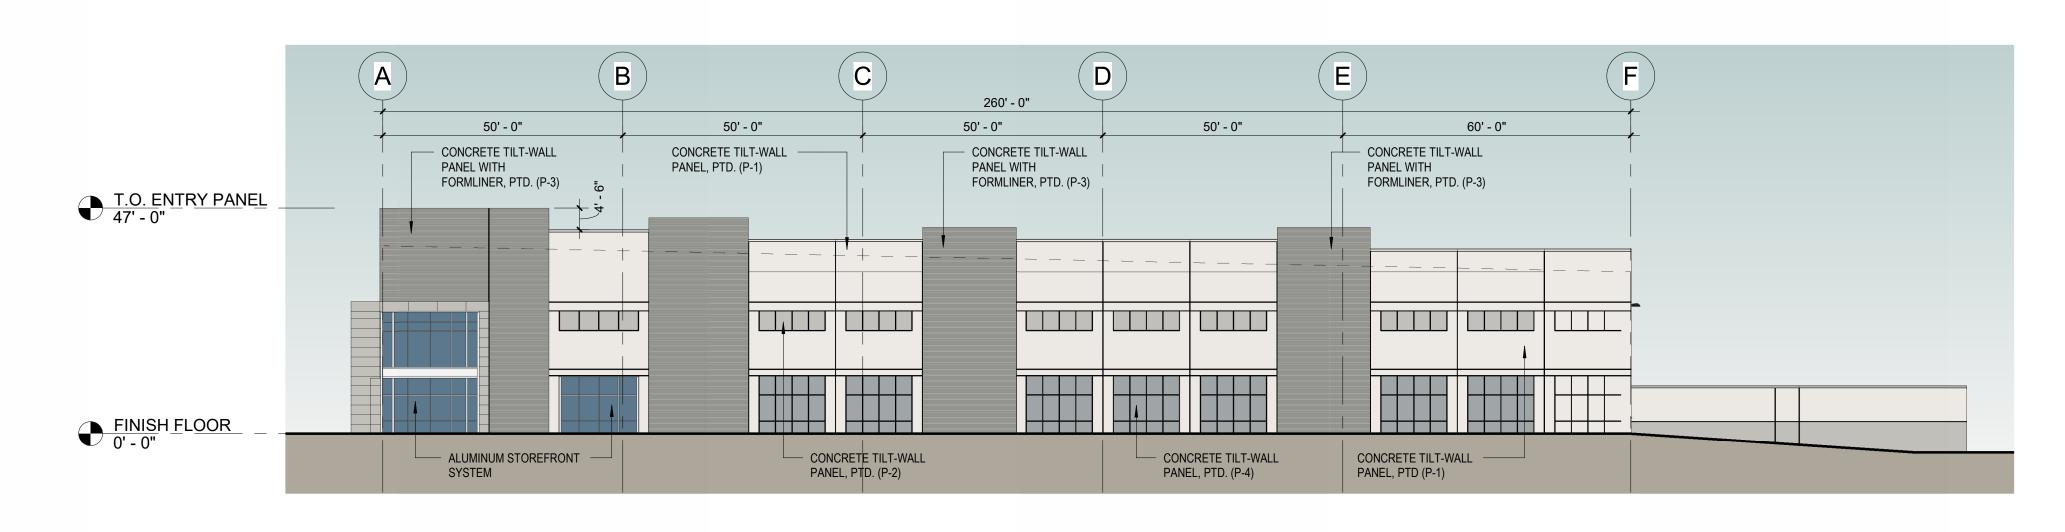

PROPOSED SOUTH ELEVATION

1" = 20'-0"



ARCHITECT
PARK McCULLAH, LLC.
5002 Village Place
Dallas, TX 75248

Contact: Kyle McCullah
214.957.7327
kylemccullah@parkmccullah.com


REV.	DATE	ISSUE TITLE
	03/20/2025	CONCEPT DESIGN PACKAGE

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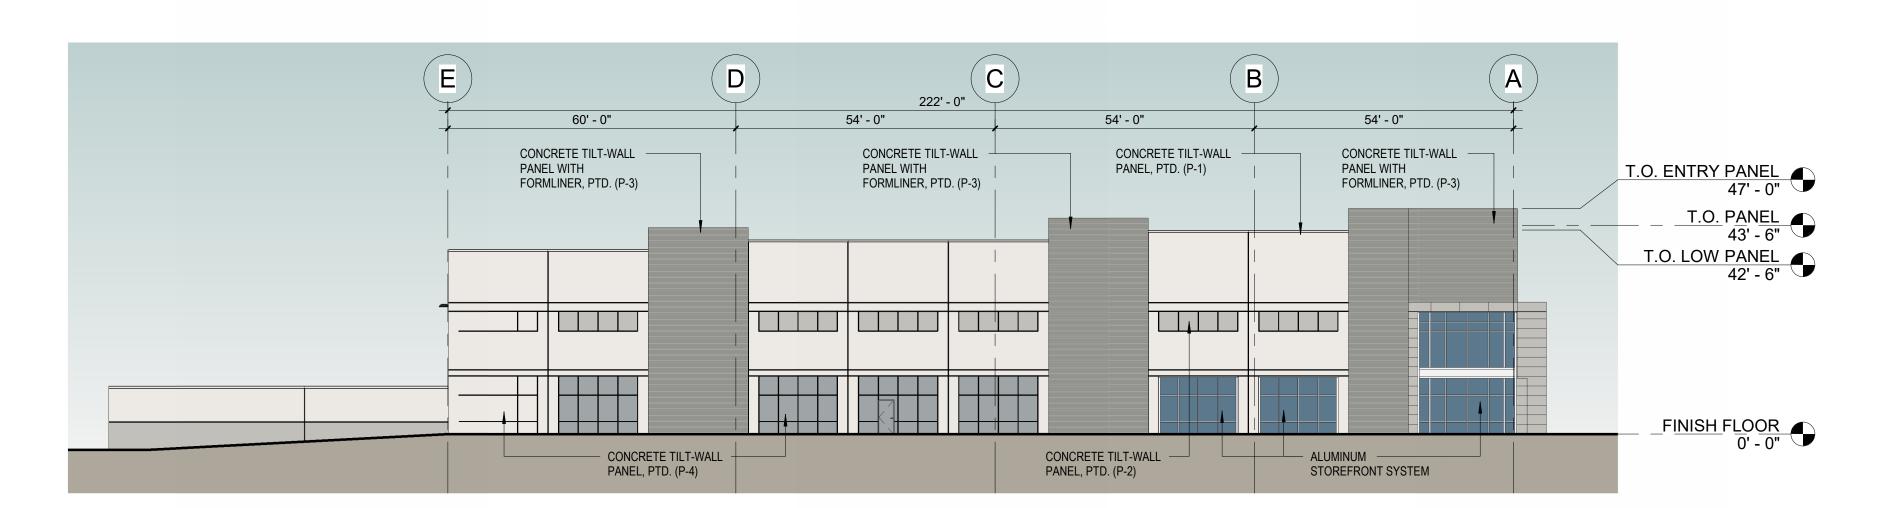
FORD ROAD FARMERS BRANCH, TEXAS 75234

PROPOSED ELEVATIONS
BUILDING C

DIM2314
PROJECT NUMBER
SHEET NUMB

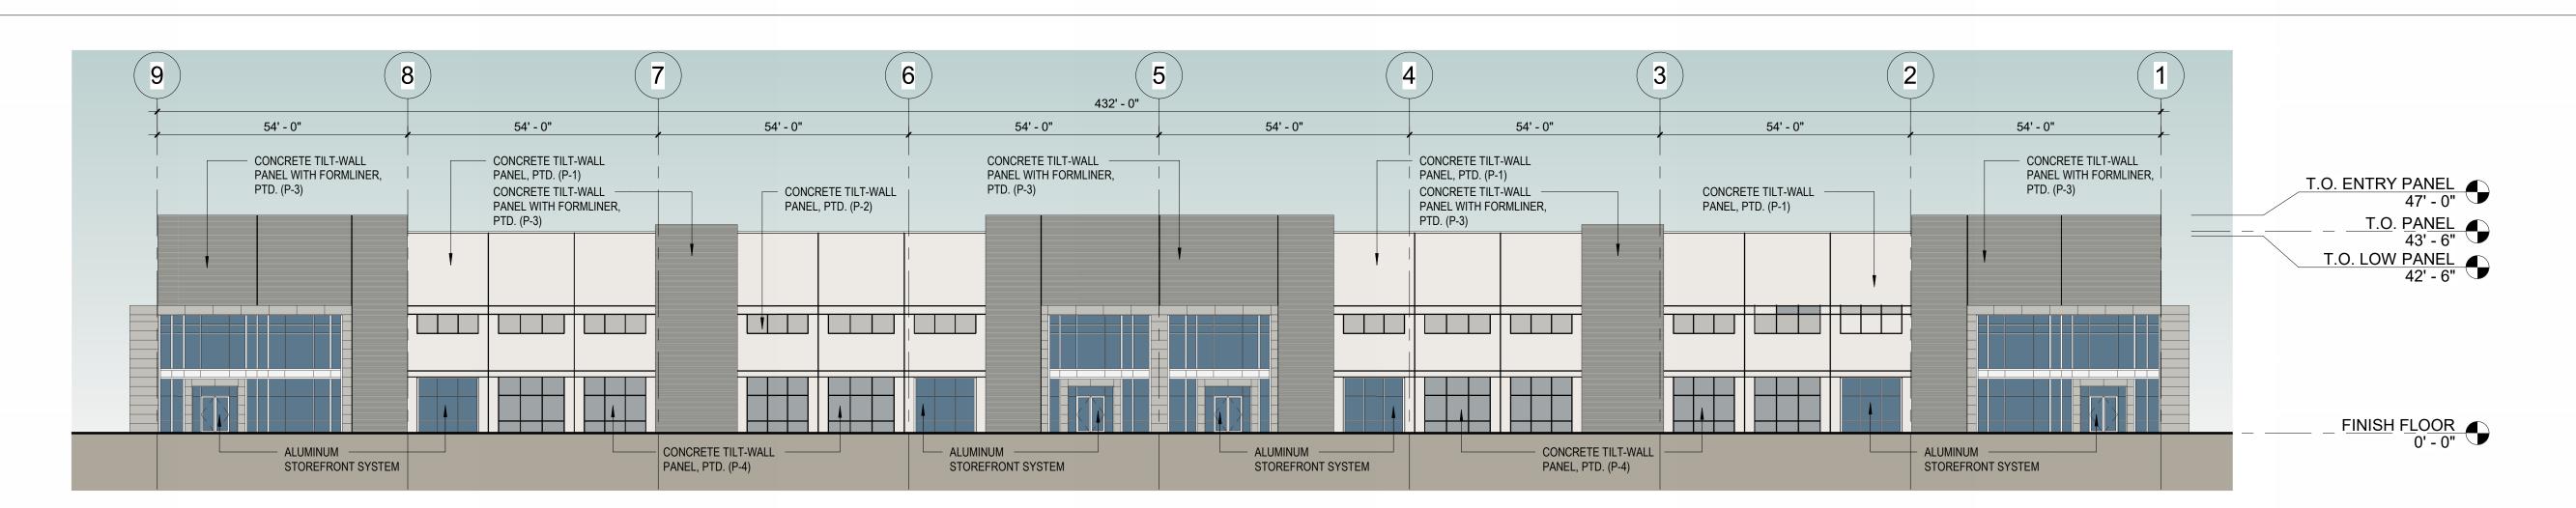


1 PROPOSED EAST ELEVATION
1" = 20'-0"




PROPOSED SOUTH ELEVATION

1" = 20'-0"

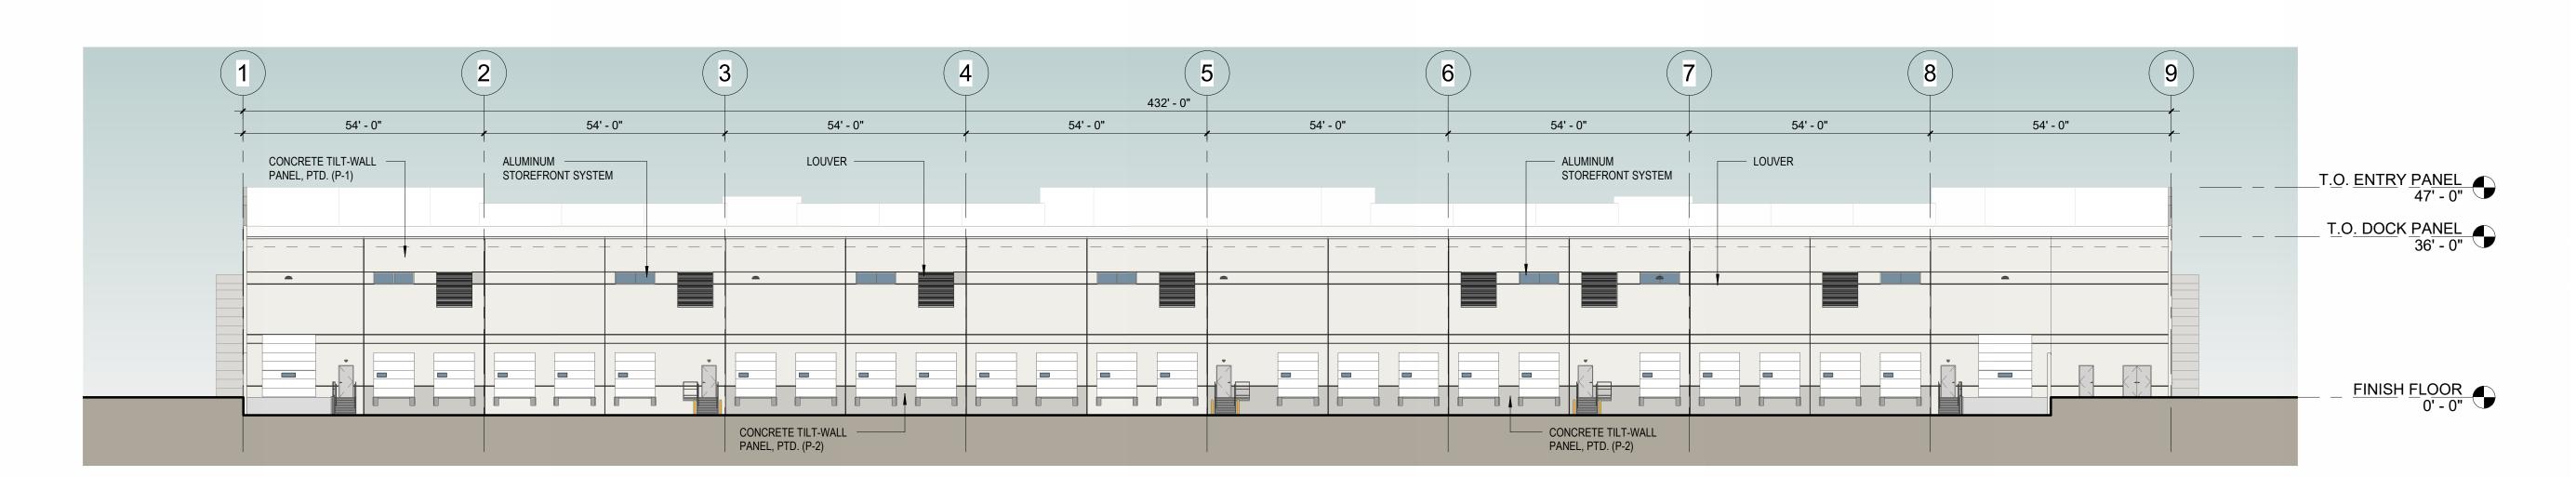

PROPOSED WEST ELEVATION

1" = 20'-0"

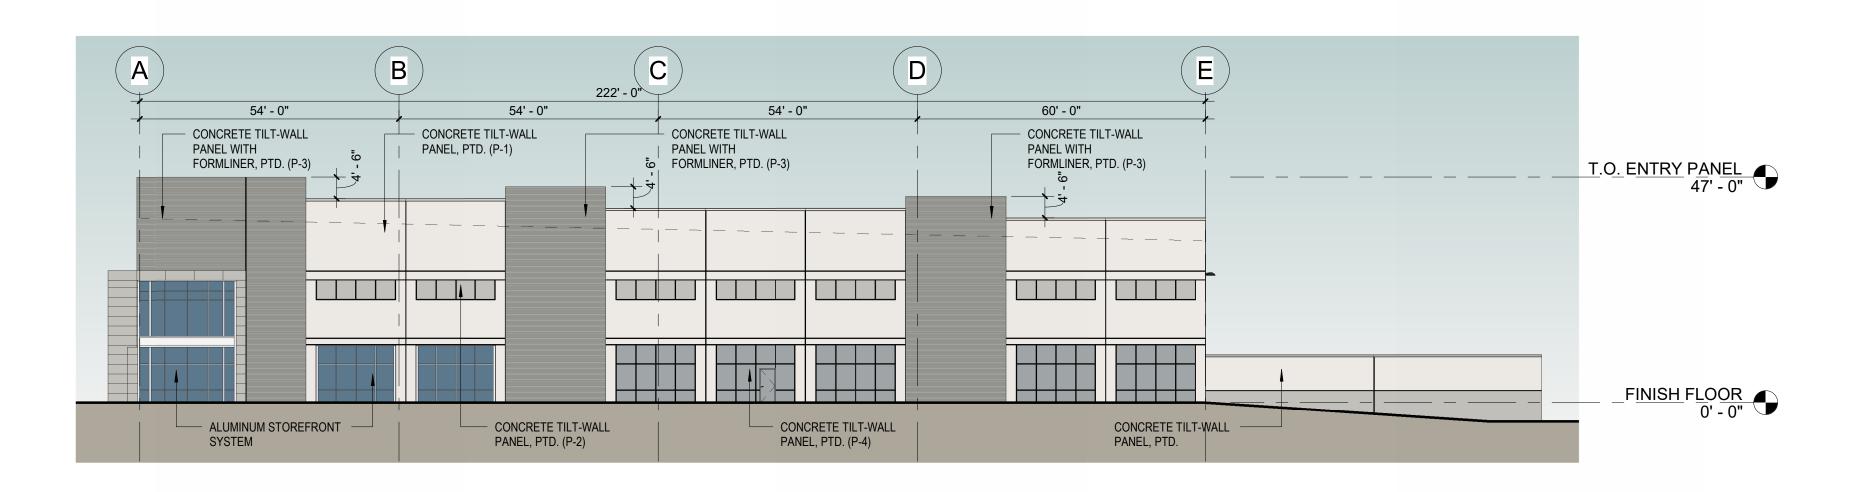

PROPOSED NORTH ELEVATION

1" = 20'-0"



ARCHITECT
PARK McCULLAH, LLC.
5002 Village Place
Dallas, TX 75248

Contact: Kyle McCullah
214.957.7327
kylemccullah@parkmccullah.com

REV.	DATE	ISSUE TITLE
	03/20/2025	CONCEPT DESIGN PACKAGE

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PERMIT OR CONSTRUCTION

FORD ROAD FARMERS BRANCH, TEXAS 75234

PROPOSED ELEVATIONS
BUILDING D

DIM2314
PROJECT NUMBER

SHEET NUMB



January 12, 2024

Mr. Mike Clark, P.E. Winkelmann & Associates, Inc. 6750 Hillcrest Plaza Dr., Suite 215 Dallas, TX 75230

Re: Trip Generation Comparison for the Proposed Office-Warehouse Development at 1200 Ford Road in Farmers Branch, TX

Dear Mr. Clark,

Below is a comparison of the projected traffic volumes for the site at 1200 Ford Road, located northeast of the Ford Road/Lydon B Johnson Freeway in Farmers Branch, Texas. The site currently contains four (4) office buildings with a total of 374,188 SF. The proposed office/warehouse development is planned to hvae three (3) buildings with a total of 393,000 SF. For the trip generation purposes, it is assumed that 10% of the proposed buildings will be office and 90% warehouse.

Traffic generated by a development, known as trip generation, is calculated based upon methods and rates published in the *Institute of Transportation Engineers (ITE) Trip Generation Manual,* 11th Edition. Trips are projected for weekday and for the AM and PM peak hours of adjacent street traffic. It should be noted that there will be additional trips in the AM and PM periods; the trips summarized herein are the peak trips in an hour time period.

Existing Office Trip Generation

Trip generation for the exiting office development is summarized in **Table 1**.

Table 1. Existing Office Trip Generation

ITE#	Use	Quantity	Weekday	AM Peak Hour			PM Peak Hour		
				Total	In	Out	Total	In	Out
710	General Office, Existing (100% Occupied)	374,188 SF	3,658	521	458	63	496	84	412

Proposed Office/Warehouse Trip Generation

The proposed office-warehouse development is projected to generate 1,112 trips per weekday, 141 trips in the AM peak hour, and 145 trips in the PM peak hour, as summarized in **Table 2**.

Table 2. Proposed Office-Warehouse Trip Generation

ITE#	Use	Quantity	Weekday	AN	1 Peak Ho	ur	PM Peak Hour		
IIE#	Ose			Total	In	Out	Total	In	Out
150	Warehouse, Future (90% of Future Buildings)	353,700 SF	597	66	51	15	69	19	50
710	General Office, Future (10% of Future Buildings)	39,300 SF	515	75	66	9	76	13	63
	Total:	393,000 SF	1,112	141	117	24	145	32	113



The number of trucks projected to the site, per the on ITE Trip Generation Manual, are summarized below in Table 3. As shown, the site is projected to generate 212 truck trips per weekday, 7 trips in the AM peak hour, and 11 trips in the PM peak hour.

Table 3. Proposed Office-Warehouse Truck Trip Generation - Trucks

ITE#	Use	Quantity	Weekday	AM Peak Hour			PM Peak Hour		
				Total	In	Out	Total	In	Out
150	Warehouse, Future (90% of Future Buildings)	353,700 SF	212	7	4	3	11	6	5

Trip Generation Comparison

Traffic for the proposed site was compared to the existing office development considering the existing development occupied at 100%, 50%, and 25%. The resulting comparisons are summarized on the attached sheet.

The office-warehouse site is projected to generate fewer trips than the exiting office development. When the office fully occupied, the proposed site is projected to generate 2,546 fewer trips on a weekday, 380 fewer trips in the AM peak hour, and 351 fewer trips in the PM peak hour.

Even when considering the existing office development only 25% occupied, the proposed site is projected to generate 17 fewer trips in the AM peak hour, and 12 fewer trips in the PM peak hour.

Please let me know if you have any questions.

Thank you,

Lambeth Engineering Associates, PLLC

Christy Lambeth, P.E., PTOE

President



Trip Generation Comparison Tables

Table 4. Existing Office Park 100% Occupied Trip Generation

ITE#	Haa	Quantity	Weekday	AN	1 Peak Ho	ur	PM Peak Hour		
IIE#	Use			Total	In	Out	Total	In	Out
Existin	g - 100% Occupied								
710	General Office, Existing (100% Occupied)	374,188 SF	3,658	521	458	63	496	84	412
Propos	sed								
150	Warehouse, Future (90% of Future Buildings)	353,700 SF	597	66	51	15	69	19	50
710	General Office, Future (10% of Future Buildings)	39,300 SF	515	75	66	9	76	13	63
	Proposed Total:	393,000 SF	1,112	141	117	24	145	32	113
	Difference (Proposed less 10	00% Existing):	-2,546	-380	-341	-39	-351	-52	-299

Table 5. Existing Office Park 50% Occupied Trip Generation

ITE#	Use	Quantity	Weekday	AIV	l Peak Ho	ur	PM Peak Hour		
116#	ose	Qualitity	weekuay	Total	In	Out	Total	In	Out
Existin	g - 50% Occupied								
710	General Office, Existing (50% Occupied)	187,094 SF	2,002	287	253	34	279	47	232
Propos	sed								
150	Warehouse, Future (90% of Future Buildings)	353,700 SF	597	66	51	15	69	19	50
710	General Office, Future (10% of Future Buildings)	39,300 SF	515	75	66	9	76	13	63
	Proposed Total:	393,000 SF	1,112	141	117	24	145	32	113
	Difference (Proposed less	50% Existing):	-890	-146	-136	-10	-134	-15	-119

Table 6. Existing Office Park 25% Occupied Trip Generation

ITC #	ITE# Use		Weekday	AN	1 Peak Ho	ur	PM Peak Hour		
IIE#	use	Quantity	weekday	Total	In	Out	Total	In	Out
Existin	g - 25% Occupied								
710	General Office, Existing (25% Occupied)	93,547 SF	1,095	158	139	19	157	27	130
Propos	sed								
150	Warehouse, Future (90% of Future Buildings)	353,700 SF	597	66	51	15	69	19	50
710	General Office, Future (10% of Future Buildings)	39,300 SF	515	75	66	9	76	13	63
	Proposed Total:	393,000 SF	1,112	141	117	24	145	32	113
	Difference (Proposed less .	25% Existing):	17	-17	-22	5	-12	5	-17



May 12, 2025

Mr. Mike Clark, P.E. Winkelmann & Associates, Inc. 6750 Hillcrest Plaza Dr., Suite 215 Dallas, TX 75230

Re: Trip Generation Comparison for the Proposed Office-Warehouse Development at 2645 Lyndon B Johnson Freeway in Farmers Branch, TX

Dear Mr. Clark,

Below is a comparison of the projected traffic volumes for the site at 2645 Lyndon B Johnson Freeway, located northeast of the Ford Road/Lyndon B Johnson Freeway in Farmers Branch, Texas. The site currently contains a hotel building with a total of 350 rooms. The proposed office/warehouse development is planned to have one (1) building with a total of 96,000 SF. For the trip generation purposes, it is assumed that 10% of the proposed building will be office and 90% warehouse.

Traffic generated by a development, known as trip generation, is calculated based upon methods and rates published in the *Institute of Transportation Engineers (ITE) Trip Generation Manual,* 11th Edition. Trips are projected for weekday and for the AM and PM peak hours of adjacent street traffic. It should be noted that there will be additional trips in the AM and PM periods; the trips summarized herein are the peak trips in an hour time period.

Existing Office Trip Generation

Trip generation for the existing hotel building is summarized in **Table 1**.

Table 1. Existing Hotel Trip Generation

ITE#	Use	Quantity	Weekday	AN	1 Peak Ho	ur	P	M Peak H	our
IIL#	USE .	Quantity	vveekuay	Total	In	Out	Total	In	Out
310	Hotel	350 Rooms	3,370	168	94	74	231	118	113

<u>Proposed Office/Warehouse Trip Generation</u>

The proposed office-warehouse development is projected to generate 327 trips per weekday, 56 trips in the AM peak hour, and 61 trips in the PM peak hour, as summarized in **Table 2**.

Table 2. Proposed Office-Warehouse Trip Generation

ITE#	Use	Quantity	Weekday	ΑN	1 Peak Ho	ur	PI	VI Peak H	our
115#	Ose	Quantity	weekuay	Total	In	Out	Total	In	Out
150	Warehouse, Future (90% of Future Buildings)	86,400 SF	175	34	26	8	37	10	27
710	General Office, Future (10% of Future Buildings)	9,600 SF	152	22	19	3	24	4	20
	Total:	96,000 SF	327	56	45	11	61	14	47



The number of trucks projected to the site, per the on ITE *Trip Generation Manual*, are summarized below in **Table 3**. As shown, the site is projected to generate 52 truck trips per weekday, 2 trips in the AM peak hour, and 3 trips in the PM peak hour.

Table 3. Proposed Office-Warehouse Truck Trip Generation - Trucks

ITE#	Use	Quantity	Weekday	AN	1 Peak Ho	ur	P	M Peak H	our
IIE#	Ose	Qualitity	weekuay	Total	In	Out	Total	In	Out
150	Warehouse, Future (90% of Future Buildings)	86,400 SF	52	2	1	1	3	2	1

Trip Generation Comparison

Traffic for the proposed site was compared to the existing hotel building, considering the existing development occupied at 100%, 50%, and 25%. The resulting comparisons are summarized on the attached sheet.

The office-warehouse site is projected to generate fewer trips than the existing hotel building. When the hotel is fully occupied, the proposed site is projected to generate 3,043 fewer trips on a weekday, 112 fewer trips in the AM peak hour, and 170 fewer trips in the PM peak hour.

Even when considering the existing office development only 25% occupied, the proposed site is projected to generate 198 fewer trips on the weekday.

Please let me know if you have any questions.

Thank you,

Lambeth Engineering Associates, PLLC

Christy Lambeth, P.E., PTOE

President



Trip Generation Comparison Tables

Table 4. Existing Hotel Building 100% Occupied Trip Generation


ITE#	Use	Quantity	Weekday	AN	1 Peak Ho	ur	PI	M Peak H	our
IIE#	use	Quantity	weekday	Total	In	Out	Total	In	Out
Existin	g - 100% Occupied								
310	Hotel, Existing (100% Occupied)	350 Rooms	3,370	168	94	74	231	118	113
Propos	sed								
150	Warehouse, Future (90% of Future Buildings)	86,400 SF	175	34	26	8	37	10	27
710	General Office, Future (10% of Future Buildings)	9,600 SF	152	22	19	3	24	4	20
	Proposed Total:	96,000 SF	327	56	45	11	61	14	47
	Difference (Proposed less	100% Existing):	-3,043	-112	-49	-63	-170	-104	-66


Table 5. Existing Hotel Building 50% Occupied Trip Generation

ITE#	Use	Quantity	Weekday	AIV	1 Peak Ho	ur	PI	M Peak H	our
115#	ose	Quantity	weekuay	Total	In	Out	Total	In	Out
Existin	g - 50% Occupied								
310	Hotel, Existing (50% Occupied)	175 Rooms	1,473	80	45	35	102	52	50
Propos	sed								
150	Warehouse, Future (90% of Future Buildings)	86,400 SF	175	34	26	8	37	10	27
710	General Office, Future (10% of Future Buildings)	9,600 SF	152	22	19	3	24	4	20
	Proposed Total:	96,000 SF	327	56	45	11	61	14	47
	Difference (Proposed les	s 50% Existing):	-1,146	-24	0	-24	-41	-38	-3

Table 6. Existing Hotel Building 25% Occupied Trip Generation

ITE#	Use	Quantity	Weekday	AIV	1 Peak Ho	ur	PI	M Peak H	our
IIE#	USE	Qualitity	weekuay	Total	In	Out	Total	In	Out
Existin	g - 25% Occupied								
310	Hotel, Existing (25% Occupied)	88 Rooms	525	36	20	16	37	19	18
Propos	sed								
150	Warehouse, Future (90% of Future Buildings)	86,400 SF	175	34	26	8	37	10	27
710	General Office, Future (10% of Future Buildings)	9,600 SF	152	22	19	3	24	4	20
	Proposed Total:	96,000 SF	327	56	45	11	61	14	47
	Difference (Proposed les	s 25% Existing):	-198	20	25	-5	24	-5	29

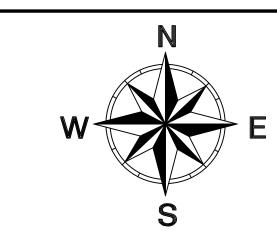

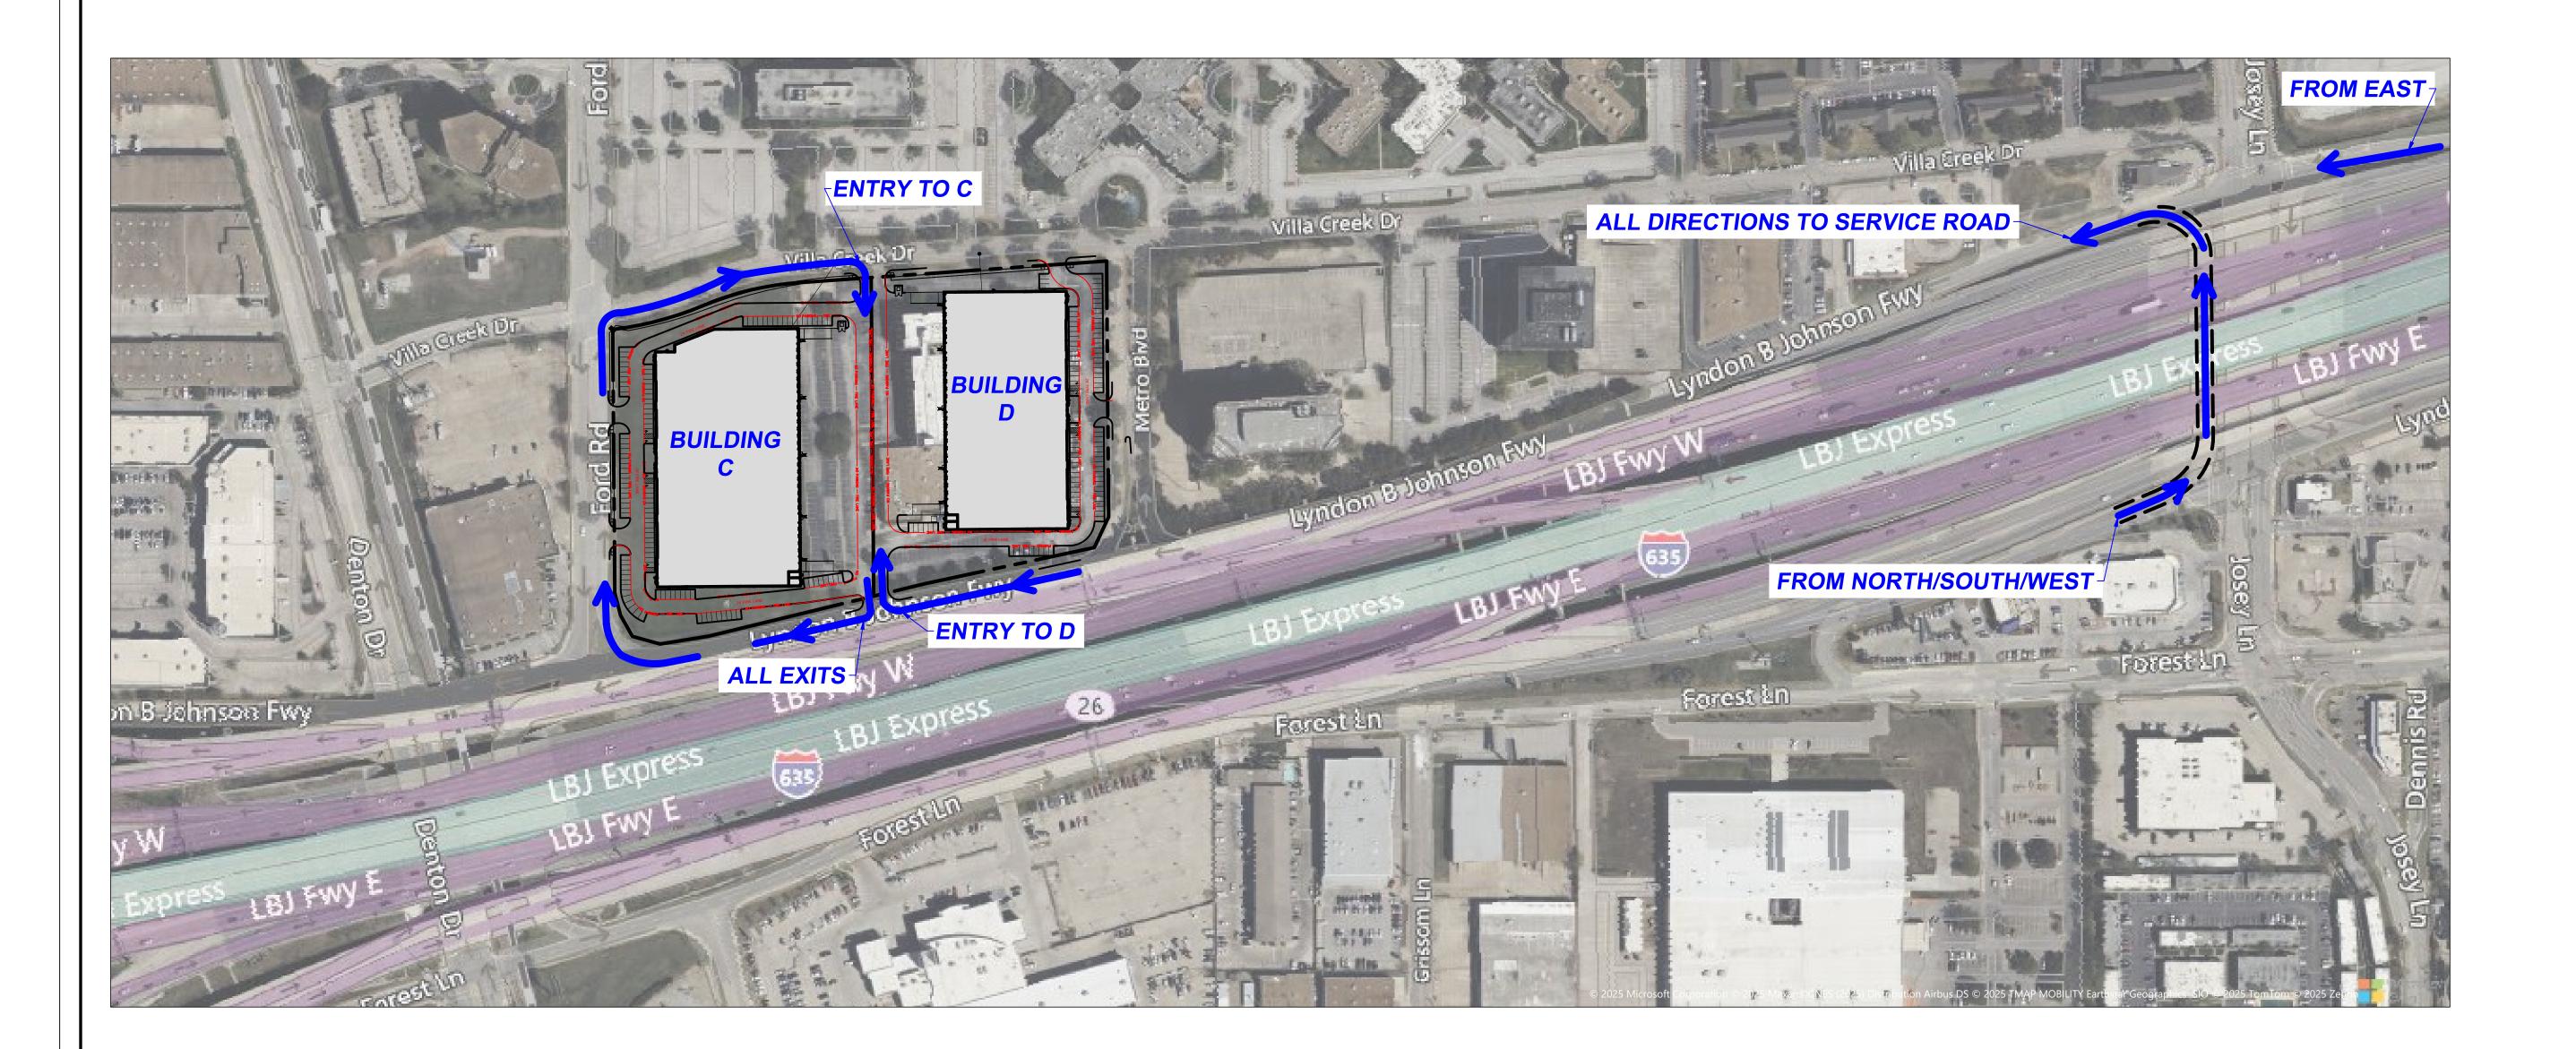

5-28-2025

EXHIBIT ROAD & LBJ 3, TX 75234

ROUTE F FORD F DALLAS, TRUCK OF NEC

01





REV. DATE ISSUE TITLE
01/15/2024 CONCEPT DESIGN PACKAGE

INCOMPLETE DOCUMENTS ARE FOR INTERIM REVIEW ONLY. NOT FOR REGULATORY APPROVAL, PERMIT OR CONSTRUCTION

FORD ROAD
FARMERS BRANCH, TEXAS
PROPOSED RENDERING

DIM2314
PROJECT NUMBER

SP-3.7
SHEET NUMBER

BUILDING A - NORTHWEST ENTRY

CONCEPT DESIGN PACKAGE - JANUARY 15, 2024





REV.	DATE	ISSUE TITLE
	01/15/2024	CONCEPT DESIGN PACKAGE

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FORD ROAD
FARMERS BRANCH, TEXAS
PROPOSED RENDERING

DIM2314
PROJECT NUMBER

SP-3.5
SHEET NUMBER

BUILDING A - VIEW CHRISTIAN PKWY

CONCEPT DESIGN PACKAGE - JANUARY 15, 2024





REV. DATE ISSUE TITLE
01/15/2024 CONCEPT DESIGN PACKAGE

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FORD ROAD
FARMERS BRANCH, TEXAS
PROPOSED RENDERING

DIM2314
PROJECT NUMBER

SP-3.9
SHEET NUMBER

BUILDING A & B - EAST ELEVATIONS

CONCEPT DESIGN PACKAGE - JANUARY 15, 2024

ORIGINAL ORDINANCE - APPROVED 2024 (EXCLUDES WYNDHAM)



ORDINANCE NO. 3850

AN ORDINANCE OF THE CITY OF FARMERS BRANCH, TEXAS AMENDING THE COMPREHENSIVE ZONING ORDINANCE AND ZONING MAP OF THE CITY OF FARMERS BRANCH, TEXAS, AS HERETOFORE AMENDED, BY AMENDING THE REGULATIONS RELATING TO THE DEVELOPMENT AND USE OF 20.8± ACRES OF LAND OUT OF THE ISAAC WEBB SURVEY ABSTRACT NO. 1574, DESCRIBED IN EXHIBIT "A," HERETO, WITHIN PLANNED DEVELOPMENT DISTRICT NUMBER 74 (PD-74); ADOPTING A CONCEPTUAL SITE PLAN; PROVIDING **FOR ADDITIONAL DEVELOPMENT REGULATIONS: PROVIDING CONFLICTS** RESOLUTION A **CLAUSE**; **PROVIDING** A SAVINGS CLAUSE; **PROVIDING** SEVERABILITY CLAUSE; PROVIDING A PENALTY OF FINE NOT TO EXCEED TWO THOUSAND DOLLARS (\$2000.00) FOR EACH OFFENSE; AND PROVIDING FOR AN EFFECTIVE DATE.

WHEREAS, the Planning and Zoning Commission of the City of Farmers Branch and the governing body of the City of Farmers Branch, in compliance with the laws of the State of Texas and the ordinances of the City of Farmers Branch, have given requisite notice by publication and otherwise, and after holding due hearings and affording a full and fair hearing to all property owners generally and to all persons interested and situated in the affected area and in the vicinity thereof, the governing body, in the exercise of the legislative discretion, has concluded that the Comprehensive Zoning Ordinance and Zoning Map should be amended;

NOW THEREFORE, BE IT ORDAINED BY THE CITY COUNCIL OF THE CITY OF FARMERS BRANCH, TEXAS, THAT:

SECTION 1. The Comprehensive Zoning Ordinance and Zoning Map of the City of Farmers Branch, Texas, is hereby amended by amending as follows the regulations of Planned Development No. 74 (PD-74), as previously amended, with respect to the use and development of the property described in "Exhibit A" attached hereto and incorporated herein by reference (said tracts collectively referred to herein as "the Property"):

- **A.** The Property shall be developed and used in accordance with the use and development regulations of Planned Development No. 74 (PD 74), as previously amended except as set forth in Section 1, Paragraphs B and C, below.
- **B.** The Property shall be used and developed in accordance with the Conceptual Site Plan, Landscape Plan, and Building Elevations attached hereto as Exhibits "B," "C," and "D," respectively and incorporated herein by reference.
- **C.** Notwithstanding the provisions of PD-74, the Property may be developed in accordance with the following development regulations:

- (1) In addition to uses listed in Section 5 of the PD-74 Development Requirements, the following uses shall be permitted by right on the Property:
 - a. Warehouse and Distribution; and
 - **b.** Light Assembly;
- (2) In addition to uses listed in Section 5 of the PD-74 Development Requirements, the Property may be developed and used for Light Fabrication Use following approval of a Specific Use Permit relating to such use;
- (3) Active operations on the Property for Warehouse and Distribution and/or Light Assembly purposes shall not commence earlier than 6:00 a.m. Central Time or be conducted later than 10:00 p.m., Central Time, each day of the week; provided, however, it shall not be a violation of this Section 1.C.(3) for people to be present on the Property outside of the foregoing hours for purposes of performing administrative and/or management tasks in association with a Warehouse and Distribution and/or Light Assembly which tasks do not involve the operation of vehicles, equipment, and/or machinery on the Property; and
- (4) Buildings constructed on the Property shall not be required to comply with the residential proximity setback requirements set forth in Section 7.A.3 of the PD-74 Development Requirements, provided the buildings are located no closer to the eastern property line of the Property as shown on the Conceptual Site Plan; and
- (5) The location of required screening walls shall be as shown on the Conceptual Site Plan. Landscape screening with a variety of tree species shall be installed between the masonry screening wall and adjacent property zoned "R-4" One-Family District as shown on the Conceptual Landscape Plan. Construction of all screening walls, including a masonry wall not less than ten (10) feet in height constructed along the eastern property line adjacent to property zoned "R-4" One-Family District, and installation of the required landscape screening must be completed prior to issuance of a certificate of occupancy for any use on the Property.
- **SECTION 2**. In the event of an irreconcilable conflict between the provisions of another previously adopted ordinance of the City of Farmers Branch and the provisions of this Ordinance, the provisions of this Ordinance shall be controlling.
- **SECTION 3.** Should any sentence, paragraph, subdivision, clause, phrase or section of this Ordinance be adjudged or held to be unconstitutional, illegal or invalid, the same shall not affect the validity of this Ordinance as a whole, or any part or provision thereof other than the part so decided to be invalid, illegal or unconstitutional, and shall not affect the validity of the Comprehensive Zoning Ordinance as a whole.
- **SECTION 4.** An offense committed before the effective date of this ordinance is governed by prior law and the provisions of the Comprehensive Zoning Ordinance, as amended, in effect when the offense was committed, and the former law is continued in effect for this purpose.

SECTION 5. Any person, firm or corporation violating any of the provisions or terms of this Ordinance shall be subject to the same penalty as provided for in the Comprehensive Zoning Ordinance of the City of Farmers Branch, as heretofore amended, and upon conviction shall be punished by a fine not to exceed the sum of Two Thousand Dollars (\$2,000) for each offense; and each and every day such violation shall continue shall be deemed to constitute a separate offense.

SECTION 6. This Ordinance shall take effect immediately from and after its passage and the publication of the caption, as the law and charter in such case provide.

DULY PASSED BY THE CITY COUNCIL OF THE CITY OF FARMERS BRANCH, TEXAS, ON THIS THE 19th DAY OF MARCH 2024.

ATTEST:

Stacy Henderson, TRMC, City Secretary

APPROVED:

Terry Lynne, Mayor

APPROVED AS TO FORM:

Peter G. Smith, City Attorney (PGS 3-6-24)

Ordinance No. 3850 Exhibit "A"- Description of Property

TRACT 1:

BEING a tract of situated in the ISAAC WEBB SURVEY, Abstract No. 1574 and being all of Tract's A-D of the Revised Final Plat of the Fourth Installment of Metro Square - Phase II, an addition to the City of Farmers Branch as recorded in Volume 79203, Page 691 of the Map Records of Dallas County, Texas (M.R.D.C.T) and being more particularly described as follows:

BEGINNING at the intersection of the northerly Right-of-Way line of VILLAGE CREEK DRIVE (60' Right-of-Way and the easterly Right-of-Way line of FORD ROAD (80' Right-of-Way);

THENCE departing the northerly Right-of-Way line of said VILLAGE CREEK DRIVE and along the easterly Right-of-Way line of said FORD ROAD North 00 degrees 07 minutes 31 seconds East a distance of 1138.75 feet to a point for corner at the intersection of the easterly Right-of-Way line said FORD ROAD and the southerly Right-of-Way line of COLLEGE DRIVE (80' Right-of-Way);

THENCE departing the easterly Right-of-Way line of said FORD ROAD and along the southerly Right-of-Way line of said COLLEGE DRIVE as follows:

South 89 degrees 52 minutes 29 second East a distance of 20.00 feet to the beginning of a curve to the right having a radius of 437.47 feet and having a chord bearing of South 80 degrees 01 minutes 47 seconds East and a chord length of 149.60 feet;

Continuing along said curve to the right through a central angle of 19 degrees 41 minutes 23 seconds and an arc length of 150.34 feet to the beginning of a curve to the left having a radius of 517.47 feet and a chord bearing of South 78 degrees 31 minutes 47 seconds East and a chord length of 150.20 feet;

Continuing along said curve to the left through a central angle of 16 degrees 41 minutes 23 second and an arc length of 150. 74 feet to the point of tangency;

South 86 degrees 52 minutes 29 seconds East a distance of 210.74 feet to the beginning of a curve to the left having a radius of 3,009.99 feet and having a chord bearing of South 88 degrees 22 minutes 17 seconds East and a chord length of 157.23 feet;

Continuing along said curve to the left through a central angle of 02 degrees 59 minutes 36 seconds and an arc length of 157.25 feet to a point for corner;

THENCE departing the southerly Right-of-Way line of said COLLEGE DRIVE South 00 degrees 07 minutes 55 second West a distance of 965.07 feet to a point for corner in the northerly Right-of-Way line of said VILLAGE CREEK DRIVE;

THENCE along the northerly Right-of-Way line of said VILLAGE CREEK DRIVE as follows;

South 86 degrees 34 minutes 18 seconds West a distance of 348.24 feet to the beginning of a curve to the left having a radius of 602.96 feet and having a chord bearing of South 77 degrees 06 minutes 48 seconds West and a chord length of 198.17 feet;

Continuing along said curve to the left through a central angle of 18 degrees 54 minutes 59 seconds and an arc length of 199.07 feet to the beginning of a curve to the right having a radius of 542.90 feet and having a chord bearing of South 75 degrees 24 minutes 02 seconds West and a chord length of 146.34 feet;

Continuing along said curve to the right through a central angle of 15 degrees 29 minutes 27 seconds and an arc length of 146.78 feet to the POINT OF BEGINNING;

CONTAINING within these metes and bounds 16.039 acres or 698,668 square feet of land more or less.

TRACT 2:

BEING a tract of land situated in the Issac B. Webb Survey, Abstract No. 1574, Dallas County, Texas and being in the City of Farmers Branch, Texas and being a tract of land conveyed to Baldwin-Harris Company recorded in Volume 85071, Page 4876 of the Deed Records of Dallas County, Texas (D.R.D.C.T.) and being more particularly described as follows;

BEGINNING at the intersection of the northerly Right-of-Way line of INTERSTATE HIGHWAY 635 (variable width Right-of-Way) and the easterly Right-of-Way line of FORD ROAD (80' Right-of-Way);

THENCE departing the northerly Right-of-Way line of said INTERSTATE HIGHWAY 635 and along the easterly Right-of-Way line of said FORD ROAD North 00 degrees 07 minutes 31 seconds East a distance of 598.08 feet to the intersection of the easterly Right-of-Way of said FORD ROAD and the southerly Right-of-Way line of VILLAGE CREEK DRIVE (60' Right-of-Way);

THENCE departing the easterly Right-of-Way line of said FORD ROAD and along the southerly Right-of-Way line of said VILLAGE CREEK DRIVE as follows;

North 83 degrees 30 minutes 42 seconds East a distance of 3.48 feet to the beginning of a curve to the left having a radius of 602.96 feet and having a chord bearing of North 75 degrees 35 minutes 00 seconds East and having a chord length of 166.34 feet;

Continuing along said curve to the left through a central angle of 15 degrees 51 minutes 24 seconds and an arc length of 166.87 feet to the beginning of a curve to the right having a radius of 542.96 feet and having a chord bearing North 77 degrees 12 minutes 10 seconds East and having a chord length of 180.12 feet;


Continuing along said curve to the right through a central angle of 19 degrees 05 minutes 45 seconds and an arc length of 180.96 feet to a point for corner;

THENCE departing the southerly Right-of-Way line of said VILLAGE CREEK DRIVE South 01 degrees 30 minutes 34 seconds East a distance of 597.12 feet to a point for corner in the northerly Right-of-Way line of said INTERSTATE HIGHWAY 635;


THENCE along the northerly Right-of-Way line of said INTERSTATE HIGHWAY 635 South 76 degrees 56 minutes 27 sec West a distance of 366.73 feet to the POINT OF BEGINNING;

CONTAINING within these metes and bounds 4.811 acres or 209,568 square feet of land more or less.


Ordinance No. 3850 Exhibit "A"- Description of Property

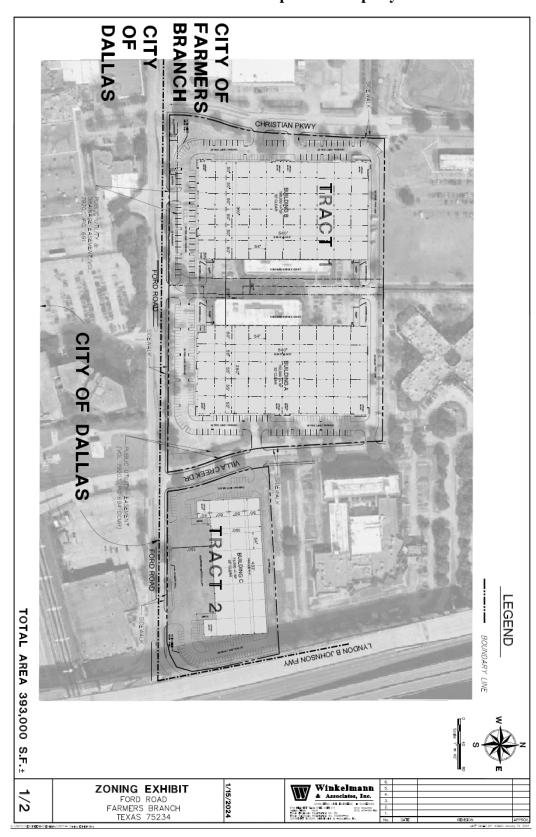


Ordinance No. 3850 Exhibit "B"- Conceptual Site Plan

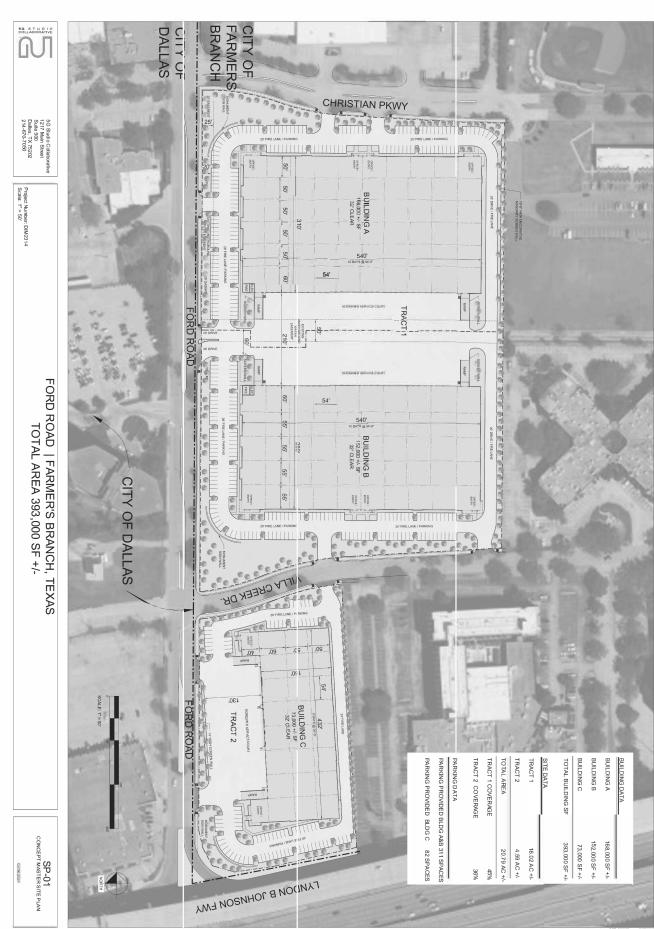


Ordinance No. 3850 Exhibit "C"- Conceptual Landscape Plan

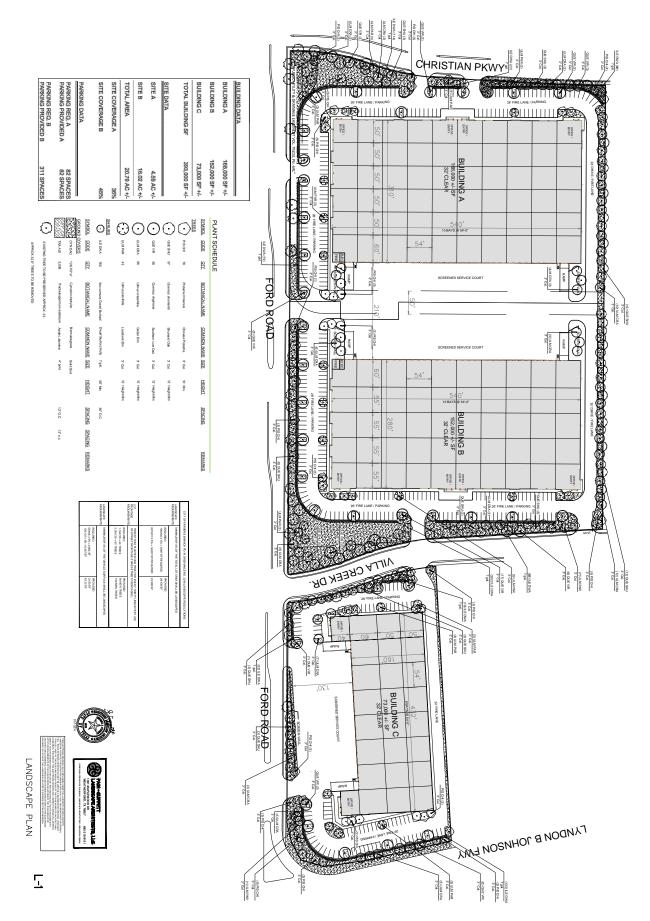

Ordinance No. 3850 Exhibit "D"- Conceptual Building Elevations

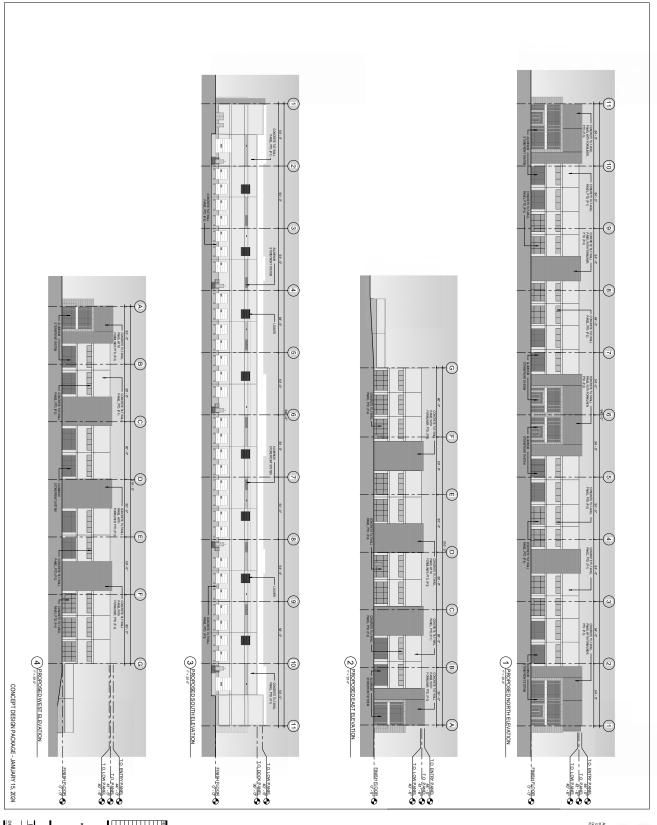

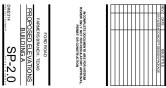




Ordinance No. 3850 Exhibit "D"- Conceptual Building Elevations





Ordinance No. 3850 Exhibit "D"- Conceptual Building Elevations

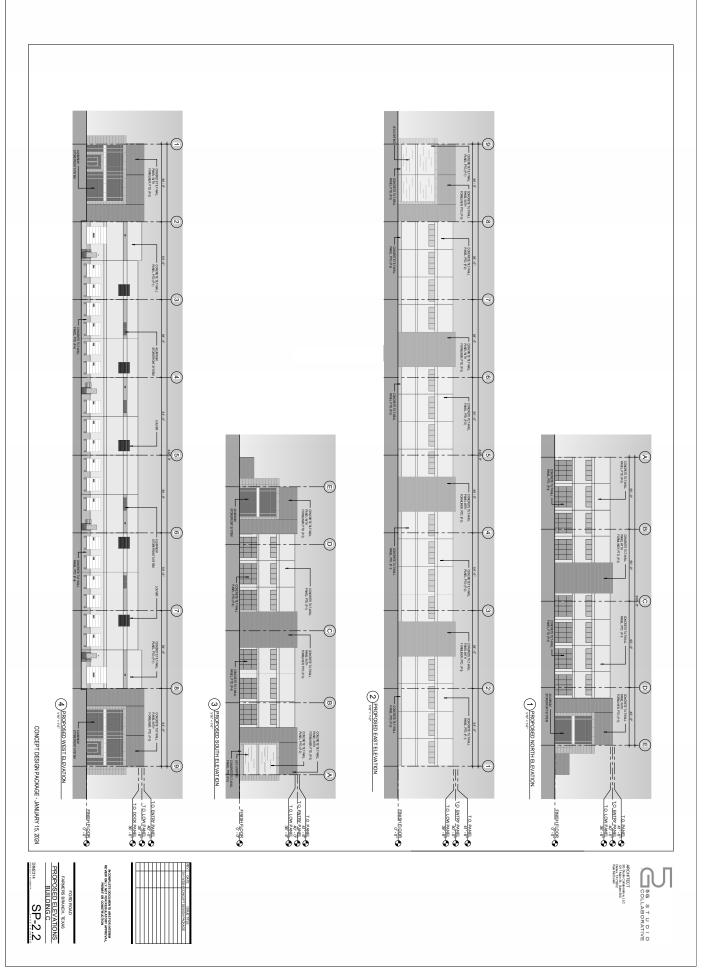

Ordinance No. 3850 Exhibit "D"- Conceptual Building Elevations

